B 02_25_26 - RIDDER PARK NORTH & SOUTH BUILDING BACK UP GENERATOR **BID SET**

1290 RIDDER PARK DR., SAN JOSE CA 95131

SANTA CLARA COUNTY OFFICE OF EDUCATION

SCOPE OF WORK

PREVIOUS PERMITS: C80-07-197, T81-11-170, H88-10-174,

AD95-791, AD96-021, GP97-4-4, PP00-025, AD13-522



San Jose, CA 95111 Phone 408.224.9890 408.224.9891 www.ArtikA3.com

Key Plan

GENERATOR

VICINITY MAP PROJECT SITE -PROJECT DIRECTORY **ARCHITECT ARTIK Art & Architecture** 394-A Umbarger Road San Jose, CA 95111 (408) 224-9890 SANTA CLARA COUNTY OFFICE OF EDUCATION

UNDERWOOD & ROSENBLUM, INC.

1630 OAKLAND ROAD, SUITE A114

SAN JOSE, CA 95131 (408) 453-1222

ANLA ASSOCIATES, INC.

SAN JOSE, CA 95125

(408) 292-2196

1213 LINCOLN AVE. SUITE 211

DUQUETTE ENGINEERING

AEC ALIANCE ENGINEERING

4701 PATRICK HENRY DRIVE

SANTA CLARA, CA 95054

CONSULTANTS, INC.

BUILDING 10

(408) 970-9888

SANTA CLARA, CA 95050

408-615-9200

1171 HOMESTEAD ROAD, SUITE 275

CIVIL

ENGINEER

LANDSCAPE

STRUCTURAL

ENGINEER

ELECTRICAL

ENGINEER

ENGINEER

Any item identified to be demolished, removed or relocated is to be completely removed, including but not limited to any concealed items (pipes, curbs, framing, beams, fasteners, etc.). All items within a demolished area that done so in accordance with appropriate specification sections in the project manual at no additional cost. If no specification can be found within the project manual, then continuity shall be maintained by current standard methods for construction but not lesser in quality than existing. Any area of demolition or removal shall be left in a completely finished condition as outlined in the project manual. All case work to be attached to walls and floors as indicated on drawings. If no specific detail is referenced. use the details referenced for similar conditions on other 10. Food handling facilities shall comply with local/ county health department requirements. 11. On Architectural, Civil, Landscape, and Plumbing sections materials and their installation shall comply with applicable 1290 RIDDER PARK DRIVE MC 254 codes, standards, and manufacturer's recommendations. SAN JOSE, CA 95131-2304 Per CBC 11B-104.1, All dimensions are subject to conventional industry tolerances except where the requirement is stated as a range with specific minimum and maximum end points. 13. General Contractor must contract the underground utility locator servicer, to review site conditions at any trenching or core drill.

GOVERNING CODES

GENERAL NOTES

Existing construction data shown on the drawings was

See architectural drawings for layout dimensions and

All discrepancies between drawings shall be clarified with

fully shown or detailed on the drawings or called for in the

general notes, then their construction shall be of the same

character as similar conditions that are shown or called for

Errors, omissions or discrepancies shall be reported to the

Dimensions, elevations, and existing conditions shall be checked and verified on the job site by each contractor.

architect before work begins or supplies are ordered.

security requirements before construction begins.

Work shall be performed in conformance with local,

Verify electrical, mechanical, fire alarm, telephone and

county, state and federal codes, laws, and regulations

all exceptions before proceeding with the work.

elevations except where indicated otherwise.

the architect prior to proceeding with work.

obtained from available drawings. The contractor shall

LIST OF 2019 CALIFORNIA CODE OF REGULATIONS (C.C.R.) as of January 1, 2019: California Administrative Code (CAC), Part I, Title 24

California Building Code (CBC) Part 2. Title 24 C.C.R. (2015 International Building Code with 2019 California Amendments) California Electric Code (CEC), Part 3, Title 24 C.C.R. (2014 National Electric Code with 2019 California Amendments) California Mechanical Code (CMC), Part 4, Title 24 C.C.R. (2015 Uniform Mechanical Code with 2019

California Amendments) California Plumbing Code (CPC), Part 5, Title 24 C.C.R. (2015 Uniform Plumbing Code with 2019

California Amendments) California Energy Code (CEnC), Part 6, Title 24

California Historical Building Code (CHBC), Part 8, Title 24 C.C.R. (2019 California Amendments) California Fire Code (CFC), Part 9, Title 24 C.C.R.

(2015 International Fire Code with 2019 California

Amendments) California Existing Building Code (CEBC). Part 10, Title 24 C.C.R. (2015 International Existing Building Code and 2019 California Amendments) 2019 California Green Building Standards Code

(CALGreen), Part 11, Title 24 C.C.R. California Referenced Standards Code, Part 12, Title 24 C.C.R. Title-19 (C.C.R.), Public Safety, State Fire Marshal Regulations.

ASME A17.1/CSA B44-13 Safety Code for Elevators and Escalators

ROOM IDENTIFICATION Room Name verify all existing conditions and shall notify the architect of CLASSROOM IDENTIFICATION Room Number A101 450 SF — Room Area **BUILDING SECTION** In the event that certain features of the construction are not **DEMOLITION KEY** NOTE NUMBER **KEY NOTE NUMBER** PARTITION TYPE CASEWORK **IDENTIFICATION REVISION CEILING HEIGHT** $\langle A \rangle$ WINDOW TYPE **NORTH ARROW** DOOR IDENTIFICATION **CONTROL POINT**

ABBREVIATIONS

GALVANIZED

G.W.B. GYPSUM WALL BOARD

GALVANIZED IRON

GRAB BAR

SYMBOL LEGEND

۸.	ASPHALT CONCRETE	CVD	CVDCLIM	
A.C.	AGENCIALI	GYP.	GYPSUM	
ACCESS.	ACCESSIBLE	H.B.	HOSE BIB	
ΔFF	ABOVE FINISH FLOOR	I.D.	INSIDE DIAMETER	
ADOLL	ARCHITECTURAL			
ARCH.	ARCHITECTURAL	IN.	INCH	
ASSEM	ASSEMBLY	INFO.	INFORMATION	
	BOARD			
BD.		INSUL.	INSULATION	
BLDG.	BUILDING	LAV.	LAVATORY	
BLK.	BLOCK	MAX.	MAXIMUM	
BLKG.	BLOCKING	MTL.	METAL	
CAB.	CABINET	MFR.	MANUFACTURER	
C.B.	CATCH BASIN			
		M.H.		
	CEMENT	MIN.	MINIMUM	
CER.	CERAMIC	MISC.	MISCELLANEOUS	
	CAST IRON			
		(N)	NEW	
C.J.	CONTROL JOINT	N/A	NOT APPLICABLE	
	CENTER LINE	N.I.C.	= = = = = = = = = = = = = = = = = = = =	
CLR.		N.T.S.	NOT TO SCALE	
CLKG	CAULKING	O.C.	ON CENTER	
COL	COLUMN			
OOL.	CONODETE	O.D.	OUTSIDE DIAMETER	
CONC.	CONCRETE	OFCI	OWNER FURNISHED	
CONF	CONFERENCE		CONTRACTOR INSTALLED	
CONINI	CONNECTION	000		
	CONNECTION	OPP.	OPPOSITE	
CONT.	CONTINUOS	PAV.	PAVING	
CORR.	CORRIDOR	P.D.F.	POWDER DRIVEN FASTENER	
	CEMENT PLASTER FINISH			
C.P.F.			PLATE	
	SYSTEM	P.T.D.	PAPER TOWEL DISPENSER	
CTSK.	COUNTERSINK	RAD.	RADIUS	
CTR.	CENTER			
		REF.	REFRIGERATOR	
C.W.	COLD WATER	RM.	ROOM	
DBL.	DOUBLE	R.D.	ROOF DRAIN	
D.F.	DRINKING FOUNTAIN	REQ.		
	DETAIL	R.C.P.	REFLECTED CEILING PLAN	
DIA.	DIAMETER	RVL.	REVEAL	
DIM.	DIMENSION	R.W.L.	RAIN WATER LEADER	
	DOWN	1 \. \ \ \ \ \ \ \ \ \ \ \ \ \ \ \ \ \ \	OFF A DOLUTEOU DAL DE AVAILLO	
DN.	_	S.A.D.		
DR.	DOOR	S.C.	SOLID CORE	
DS.	DOWNSPOUT	S.D.	SOAP DISPENSER	
	DRAWING		-	
DWG.	_	SEC.	SECTION	
EA.	EACH	SHT.	SQUARE FOOT	
E.J.	EXPANSION JOINT	SIM	SHEET SIMILAR	
	ELEVATION			
ELEV.		S.M.S.	SHEET METAL SCREW	
ELEC.	ELECTRICAL	SPEC.	SPECIFICATION	
EQ.	EQUAL	STD.	STANDARD	
	EXISTING			
(E)		STL.		
	EXTERIOR	STRUCT.	STRUCTURAL	
EXP.	EXPANSION	T.C.	TOP OF CURB	
	FIRE ALARM	TEL	TELEPHONE	
,				
	FLOOR DRAIN	T.O.P.	TOP OF PARAPET	
FDN.	FOUNDATION	T.P.	TOP OF PAVEMENT	
F.E.	FIRE EXTINGUISHER	T.P.D.	TOILET PAPER DISPENSER	
F.H.	FIRE HYDRANT	T.W.	TOP OF WALL	
FHWS	FLAT HEAD WOOD SCREW	TYP	TYPICAL	
FIN.	FINISH	U.O.N.	UNLESS OTHERWISE NOTED	
	FINISH FLOOR			
F.F.		V.I.F.	VERIFY IN FIELD	
F.P.	FIRE PROTECTION	W/	WITH	
FT.	FOOT	W.C.	WATER CLOSET	
GA.	GAUGE			
GA.	5, 10 OL	WD.	WOOD	

WITHOUT

WATERPROOF

WATER RESISTANT

WEATHER STRIPPING

W.P.

W.R.

W.S..

INSTALLATION OF TWO 600 KW BACKUP GENERATORS - S1-SOUTH GENERATOR, CONCRETE PAD, 10' WALL ENCLOSURE, AND S-2 ARCHITECURAL NORTH GENERATOR, CONCRETE PAD. 8' TALL FENCE ENCLOSURE MTS CONCRETE PAD AND ASSOCIATED ELECTRICAL, LANDSCAPE A0.01 TITLE SHEET AND CIVIL SITE WORK. A1.10 OVERALL SITE PLAN **DEMOLITION SITE PLAN** EXISTING ENLARGED PLAN **ENLARGED SITE PLAN - SOUTH GENERATOR ENLARGED SITE PLAN - NORTH GENERATOR** SOUTH GENERATOR - ENLARGED PLAN & EXTERIOR ELEVATIONS NORTH GENERATOR - ENLARGED PLAN & EXTERIOR ELEVATIONS A12.11 SITE DETAILS A12.12 SITE DETAILS A12.32 EXTERIOR DETAILS * A13.01 SITE DETAILS **STRUCTURAL** PRIOR DEVELOPMENT PERMITS

PARTIAL FENCE PLAN DETAILS

SHEET INDEX

STRUCTURAL SPECS, ABBREVIATIONS, SYMBOLS LEGEND, TABLE OF CONTENTS **GENERATOR PLANS DETAILS**

APN#: 237-03-039

C0 **COVER SHEET** OVERALL SITE PLAN **ENLARGED PLAN - N BUILDING EXISTING CONDITION**

ENLARGED PLAN - S BUILDING EXISTING CONDITION ENLARGED PLAN - N BUILDING GRADING AND UTILITY PLAN ENLARGED PLAN - S BUILDING GRADING AND UTILITY PLAN

LANDSCAPE IRRIGATION COVER SHEET IRRIGATION PLAN **IRRIGATION DETAILS**

SOUTH BAY RECYCLED WATER IRRIGATION NOTES AND DETAILS

L2.1 PLANTING PLAN L2.2 TREE MITIGATION PLAN PLANTING DETAILS

DETAILS

ELECTRICAL

E-1 **ELECTRICAL GENERAL** E-2 ELECTRICAL SITE PLAN


E-3 ENLARGED PLAN - SOUTH BUILDING BLDG #1 SERVICE

E-4 ENLARGED PLAN - NORTH BUILDING BLDG #3 SERVICE

E-5 SINGLE LINE DIAGRAM - BLDG #1 SINGLE LINE DIAGRAM - BLDG #3 E-7 **GENERATOR DETAILS** E-8 SWITCHBOARD DETAIL - BLDG #1

E-9 SWITCHBOARD DETAIL - BLDG #3 PG&E SHORT CIRCUIT LETTERS

FOR OFFICIAL USE ONLY

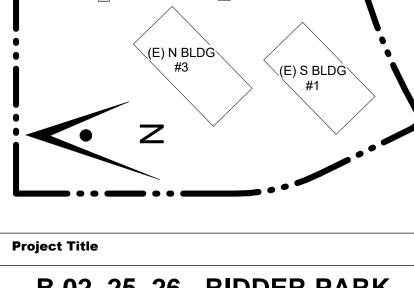

(E) E BLDG

S1 - SOUTH

GENERATOR

B 02_25_26 - RIDDER PARK NORTH & SOUTH BUILDING **BACK UP GENERATOR BID SET**

1290 RIDDER PARK DR., SAN JOSE CA 95131


Date

SANTA CLARA COUNTY OFFICE OF EDUCATION

Description

1	BID SET	09.05.25
Drawi	ing Title	

TITLE SHEET

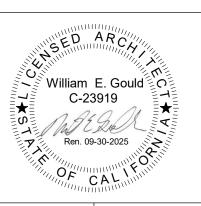


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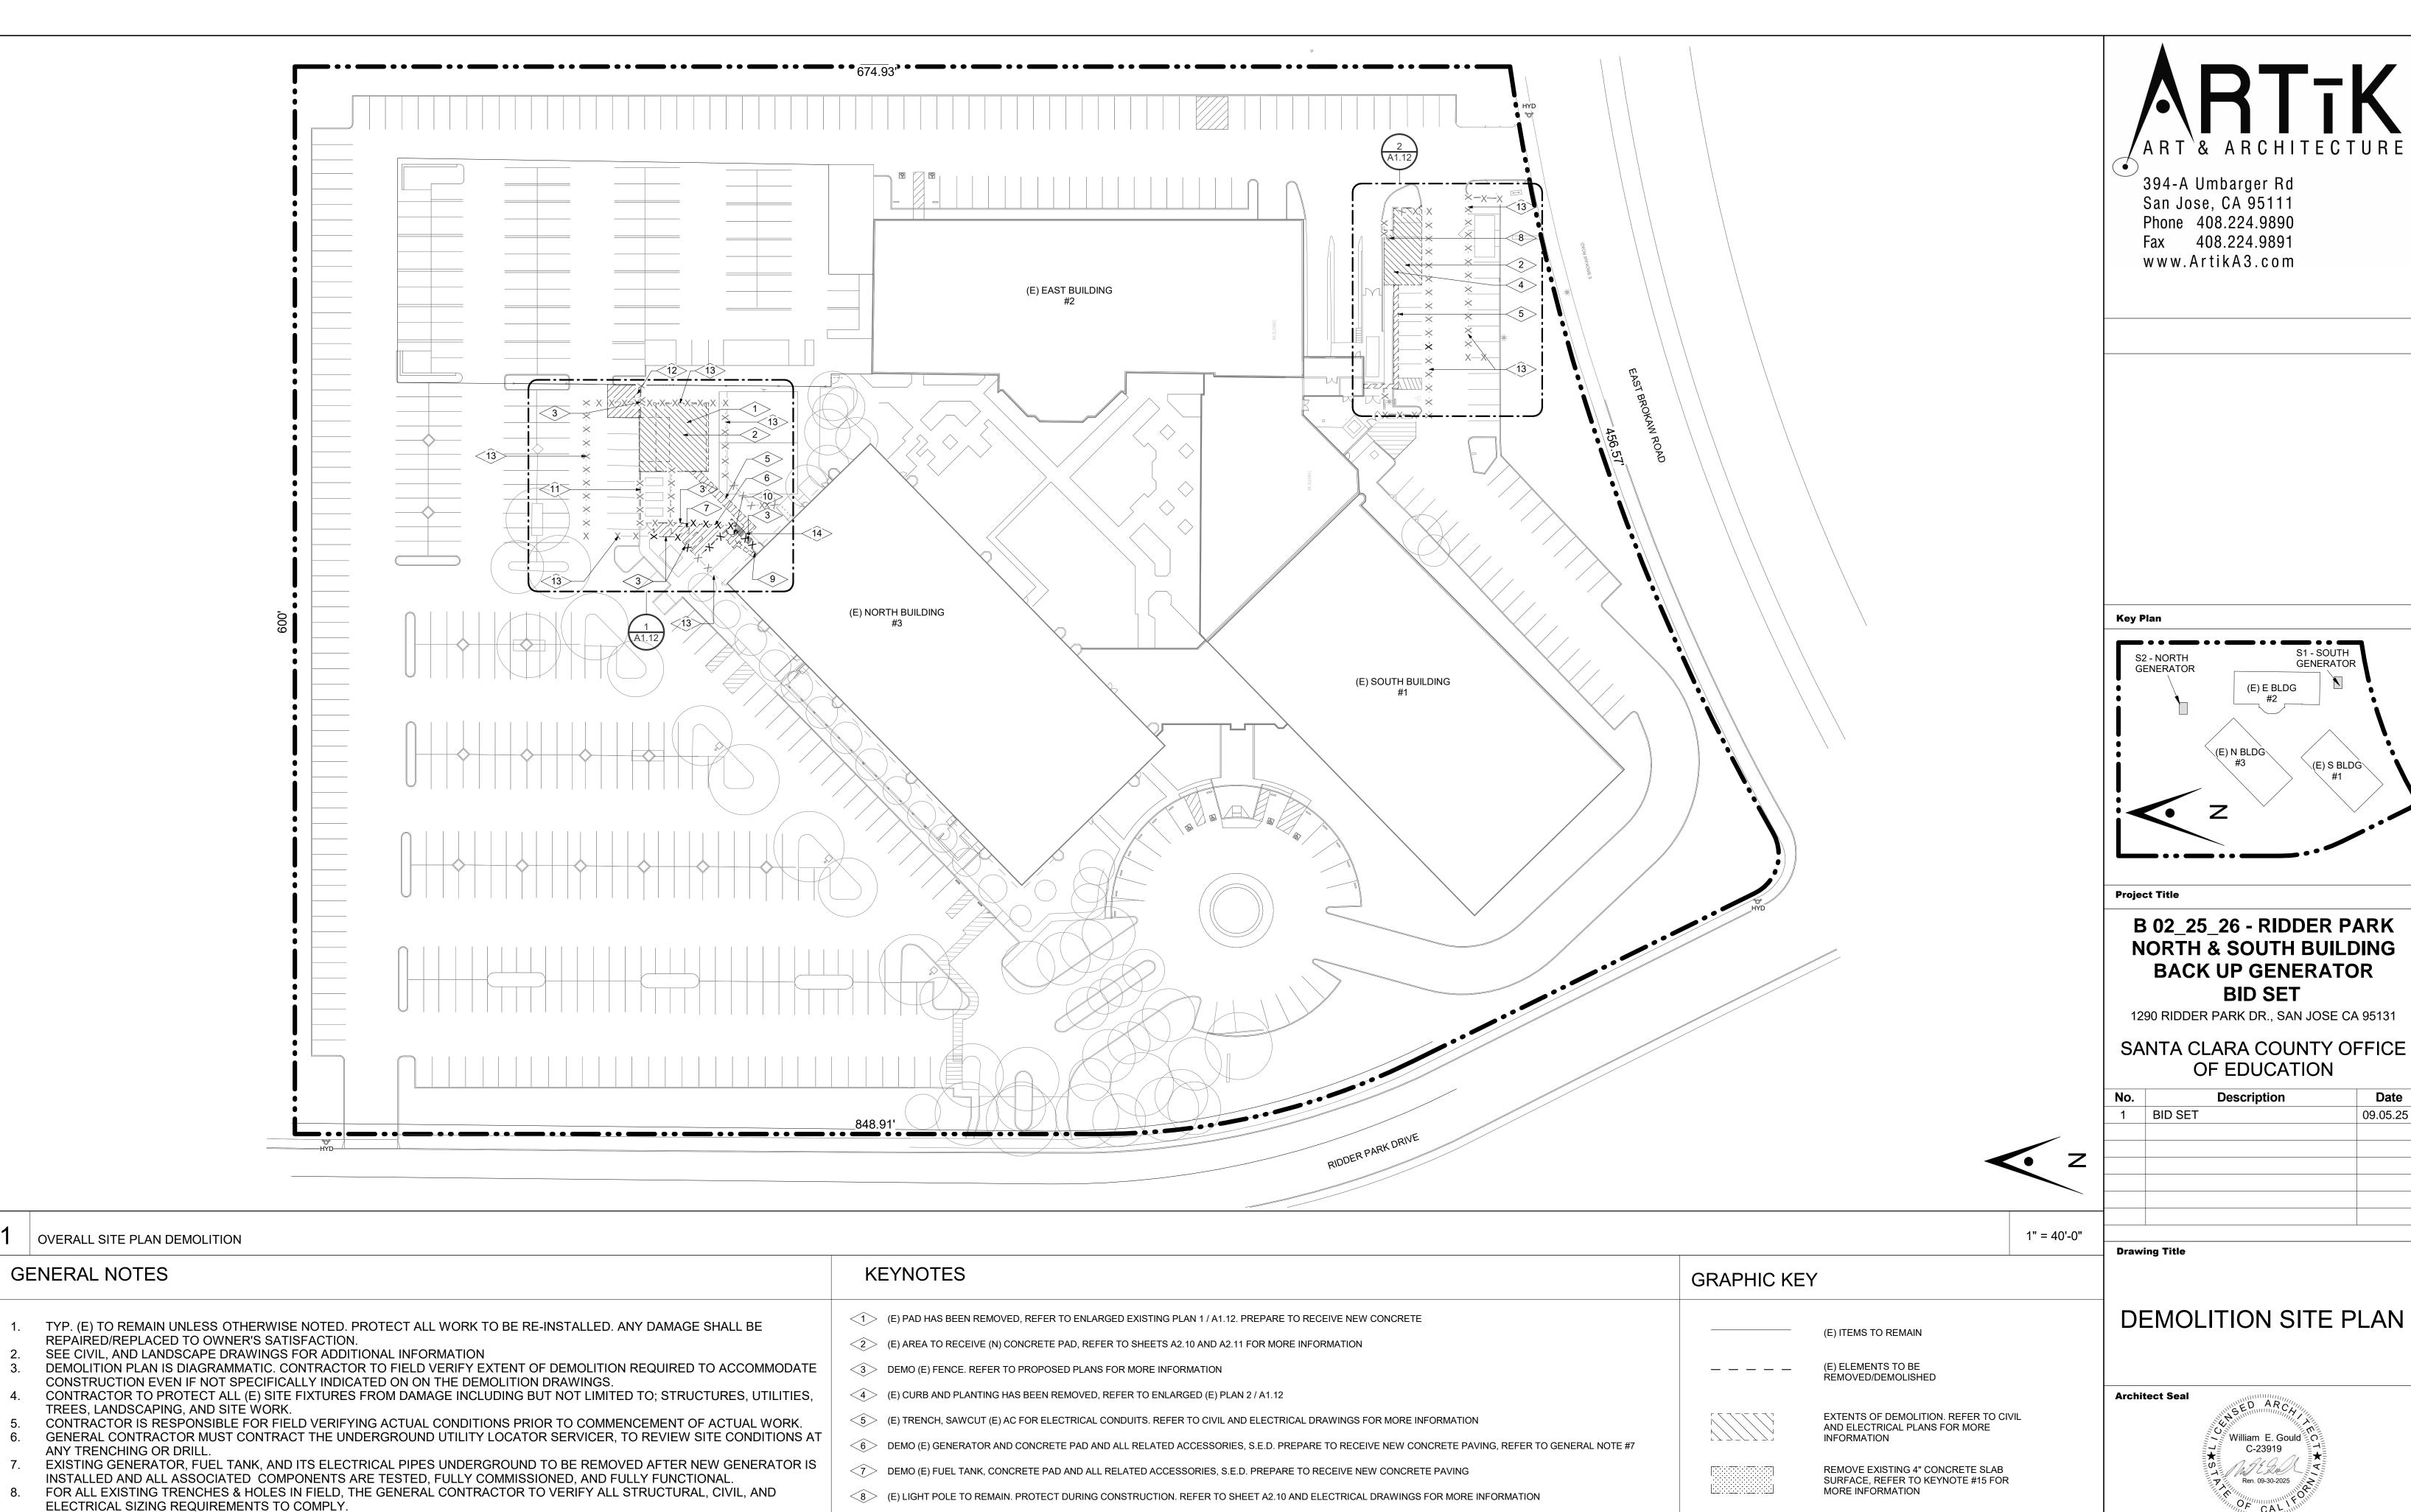
Architect Seal

Project Number

06451

Drawing No.



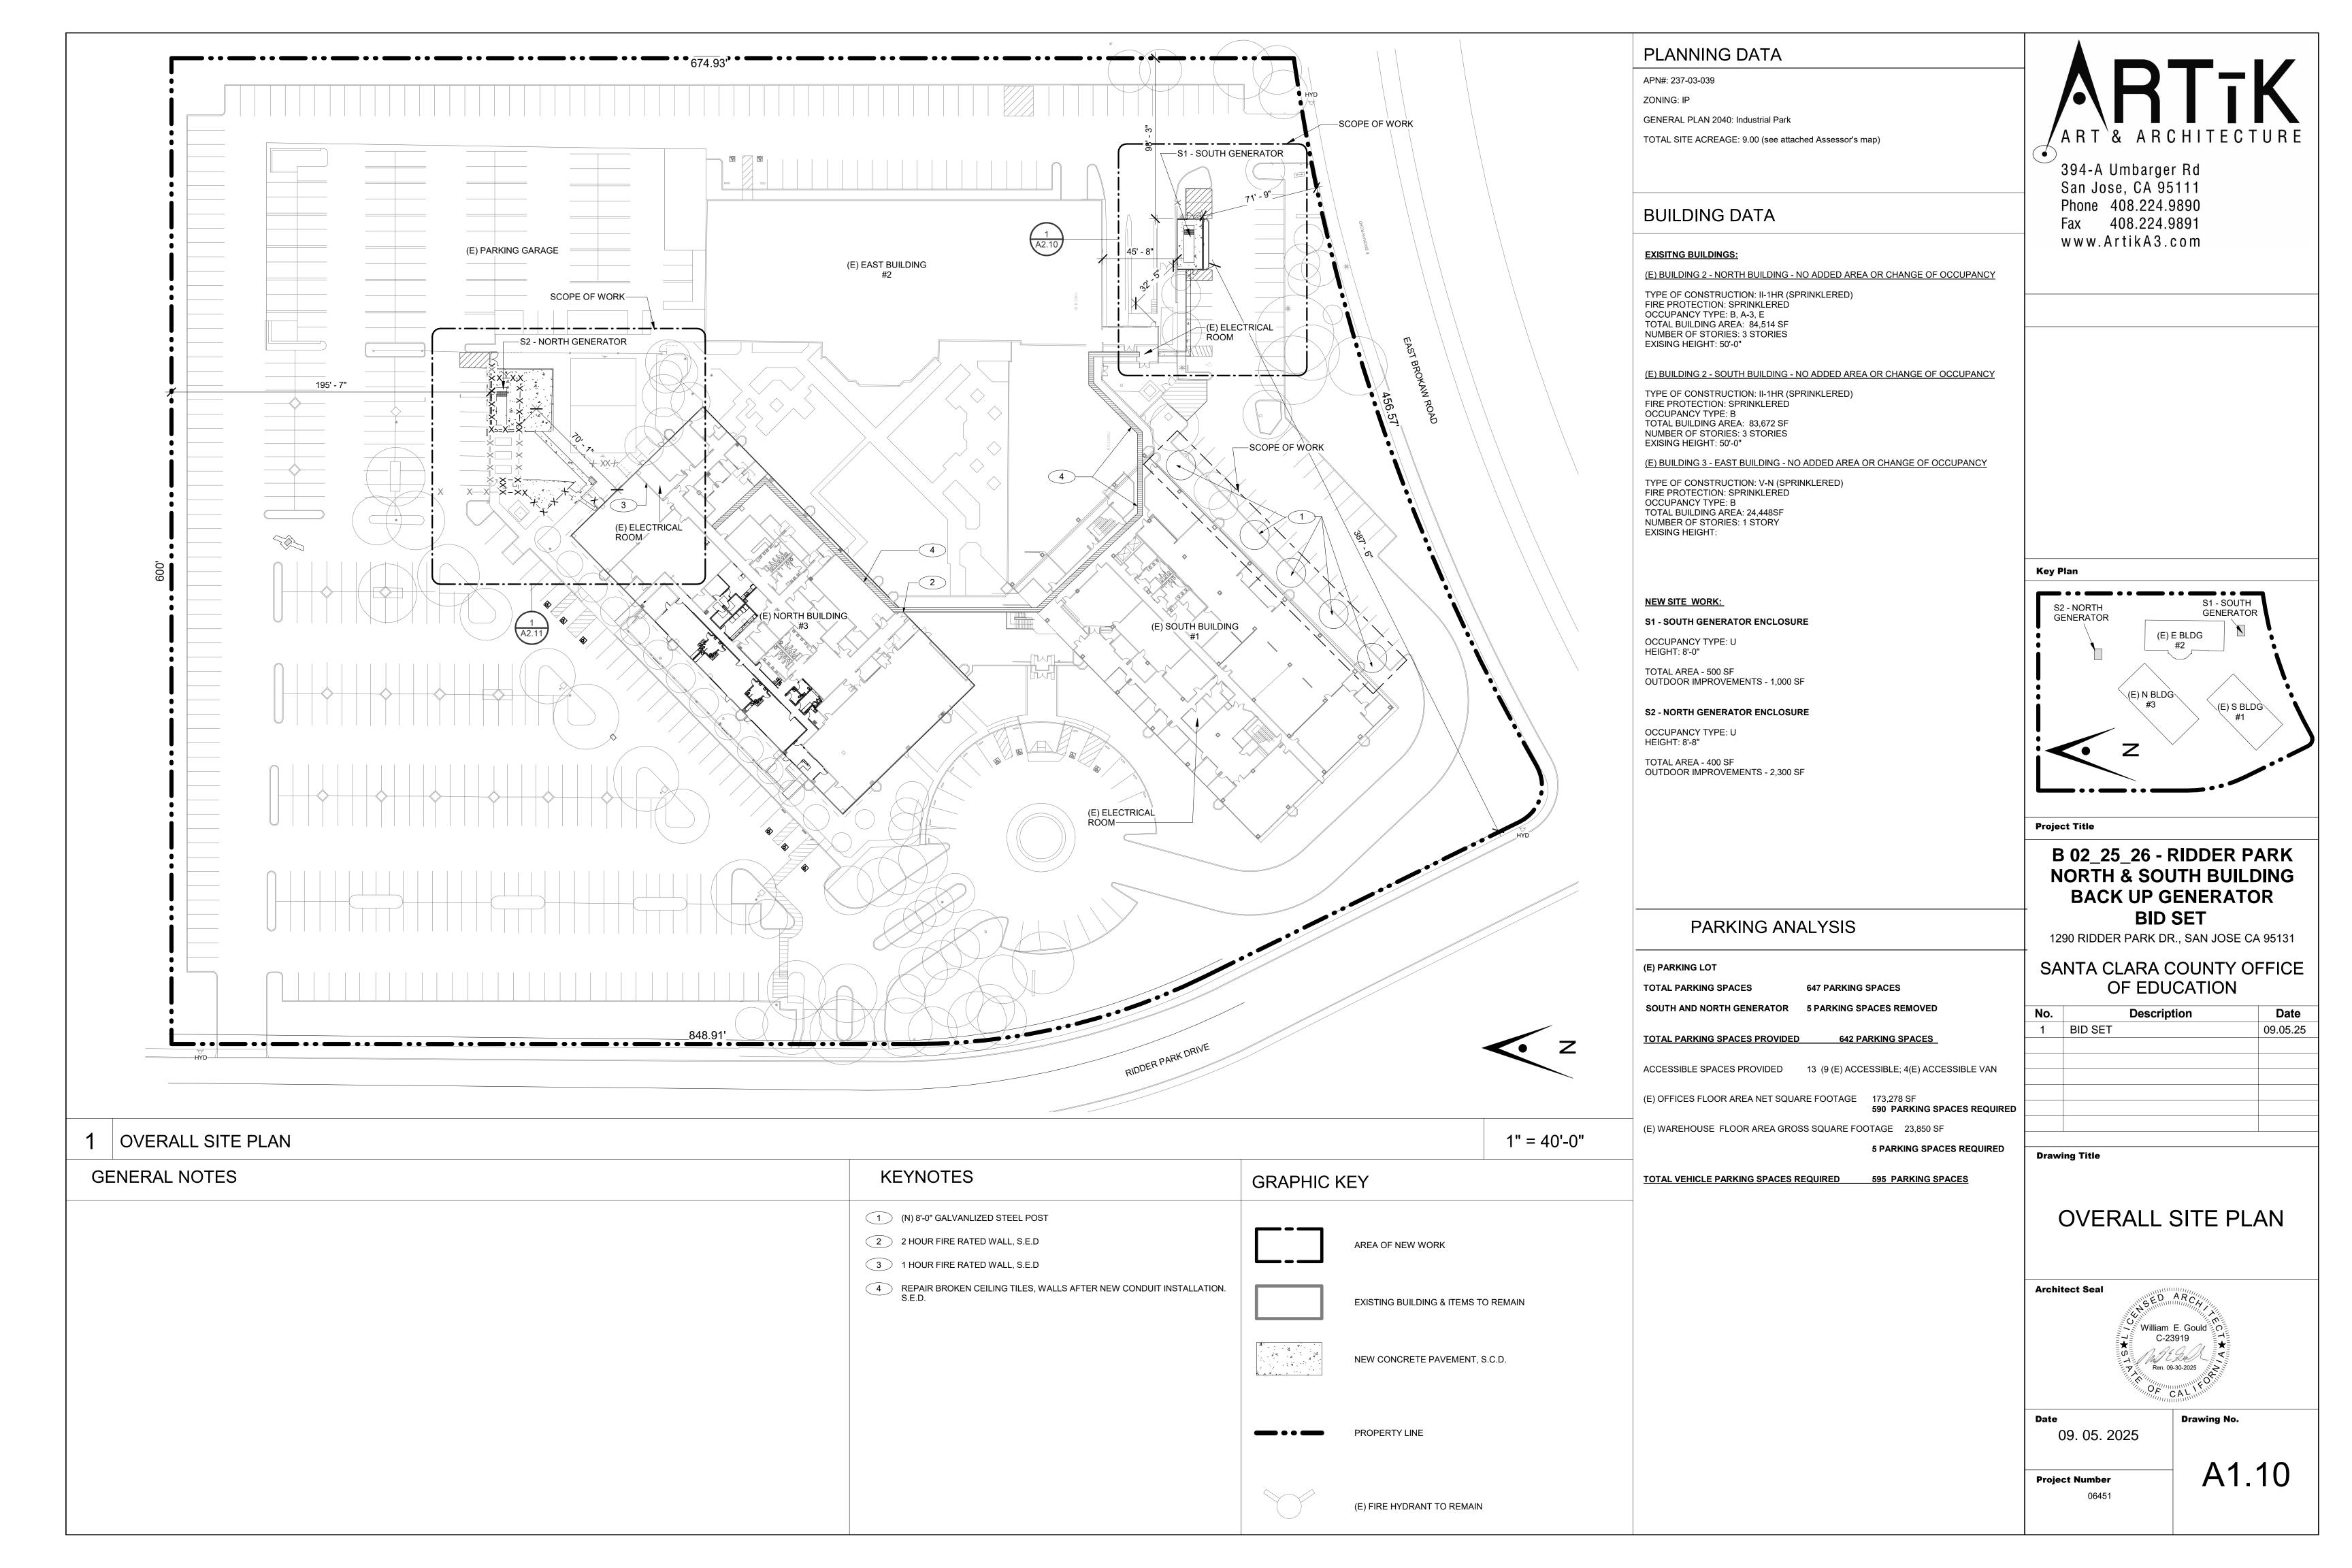

9 DEMO (E) ELECTRICAL COUNDUIT AND EQUIPMENT FOR DEMOLISHED GENERATOR

(E) CHAINLINK FENCE TO REMAIN AND BE PROTECTED DURING CONSTRUCTION

DEMO (E) DOUBLE GATE & FENCE. REFER TO PROPOSED PLANS FOR MORE INFORMATION

DEMO (E) SINGLE GATE & FENCE. REFER TO PROPOSED PLANS FOR MORE INFORMATION

(E) TEMPORARY FENCE TO BE REMOVED BY OTHERS AFTER WORK IS COMPLETED (PHASE II) COORDINATE WITH OWNER

DEMO CONCRETE SAWCUT AND TRENCH, 19'-0" L. X 3'-6" W. X 1'-4" D., REFER TO SHEET S1.1 ON STRUCTURAL DRAWINGS FOR MORE INFORMATION

DEMO CONCRETE SAWCUT AND TRENCH, 19'-0" L. X


STRUCTURAL DRAWINGS FOR MORE INFORMATION


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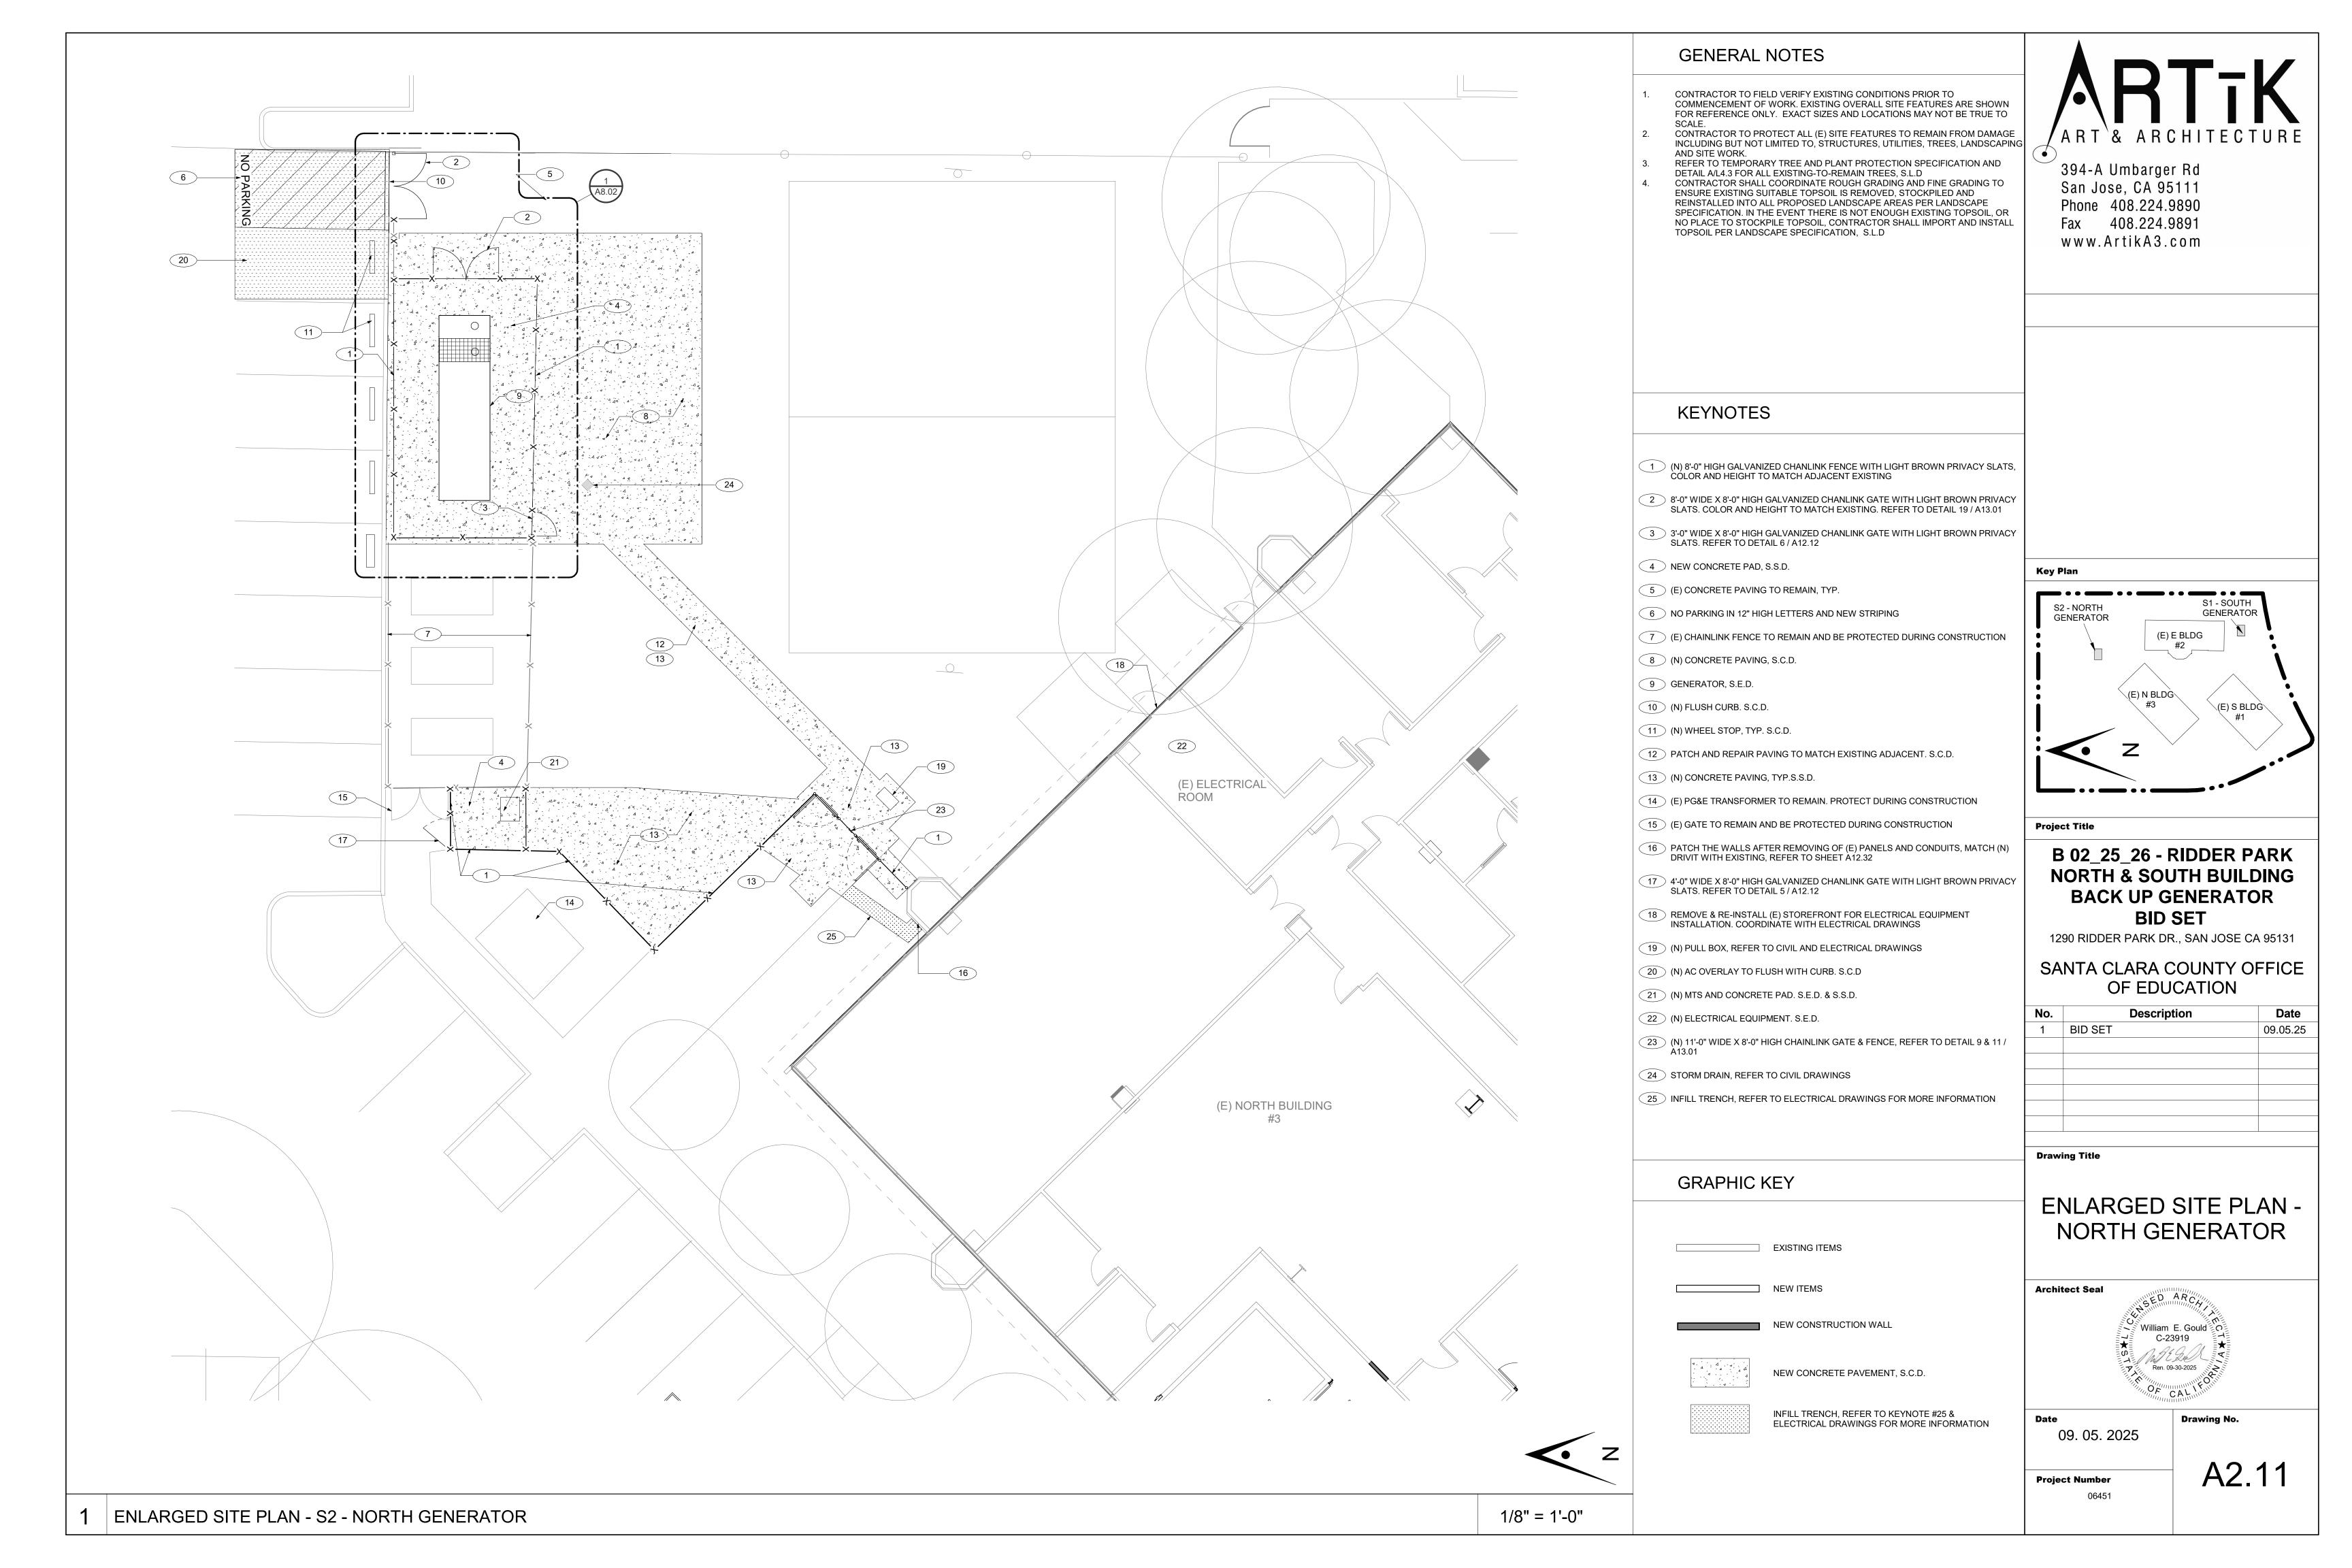
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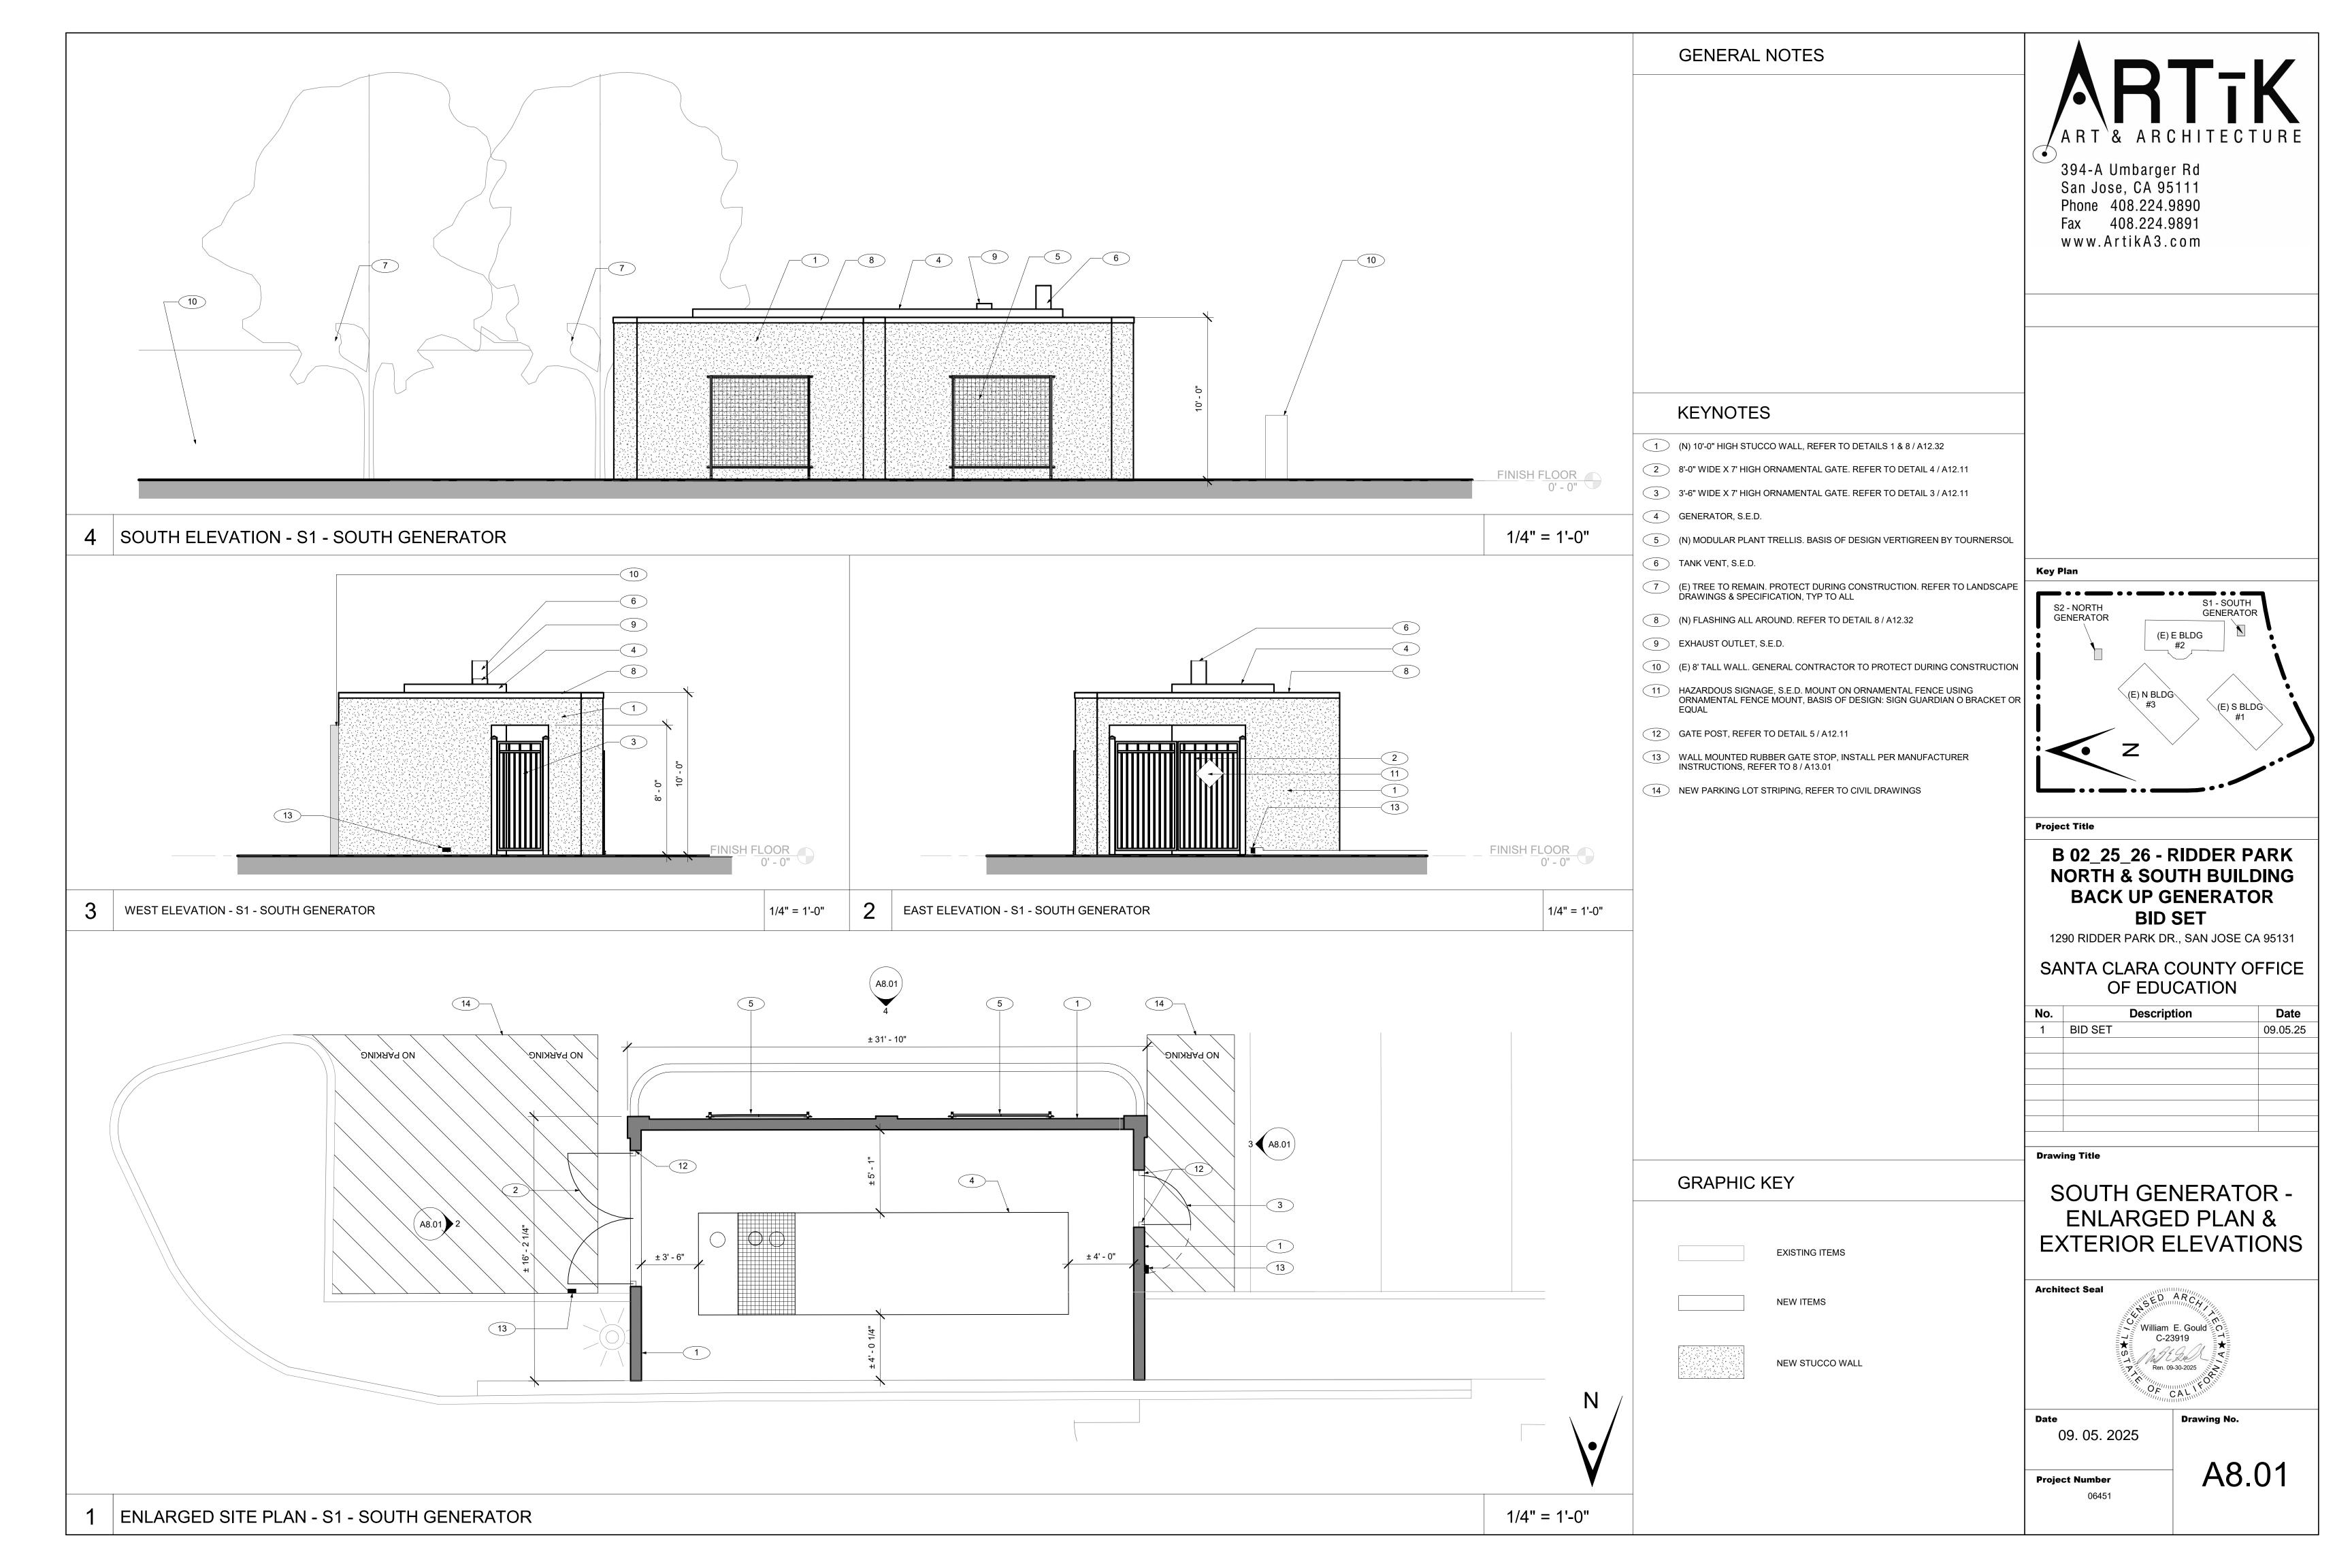
Project Number


3'-6" W. X 1'-4" D., REFER TO SHEET S1.1 ON







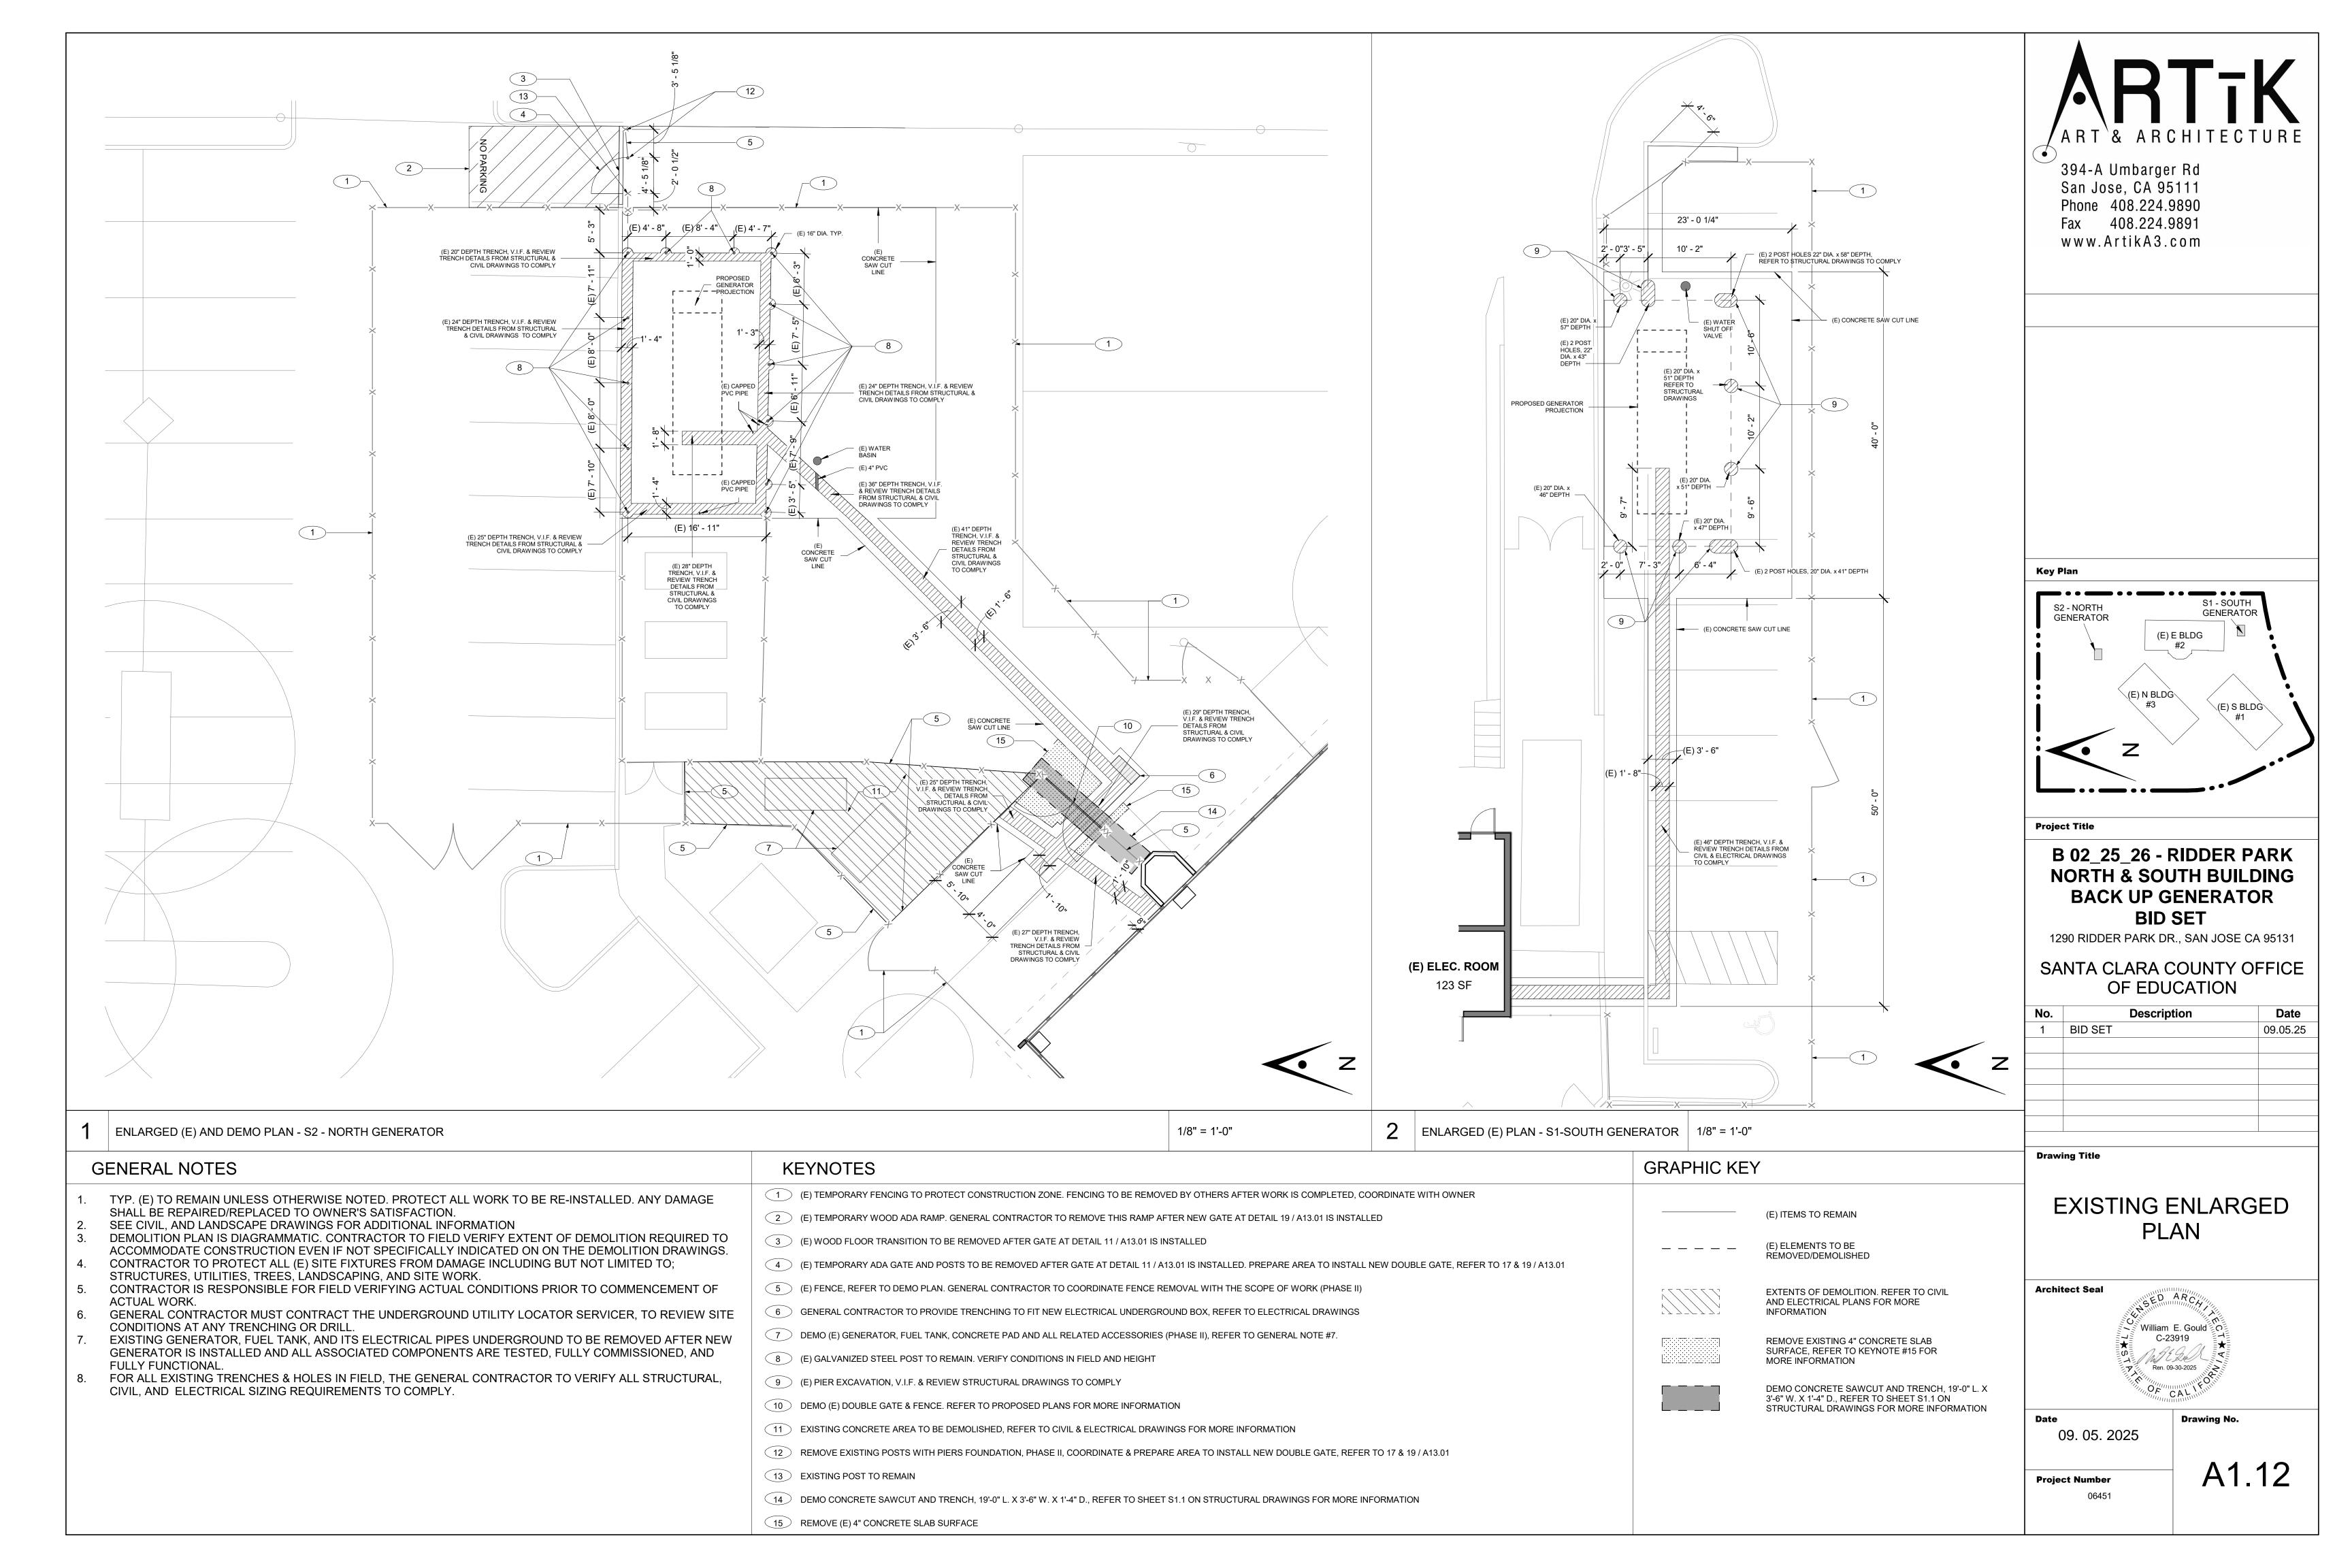


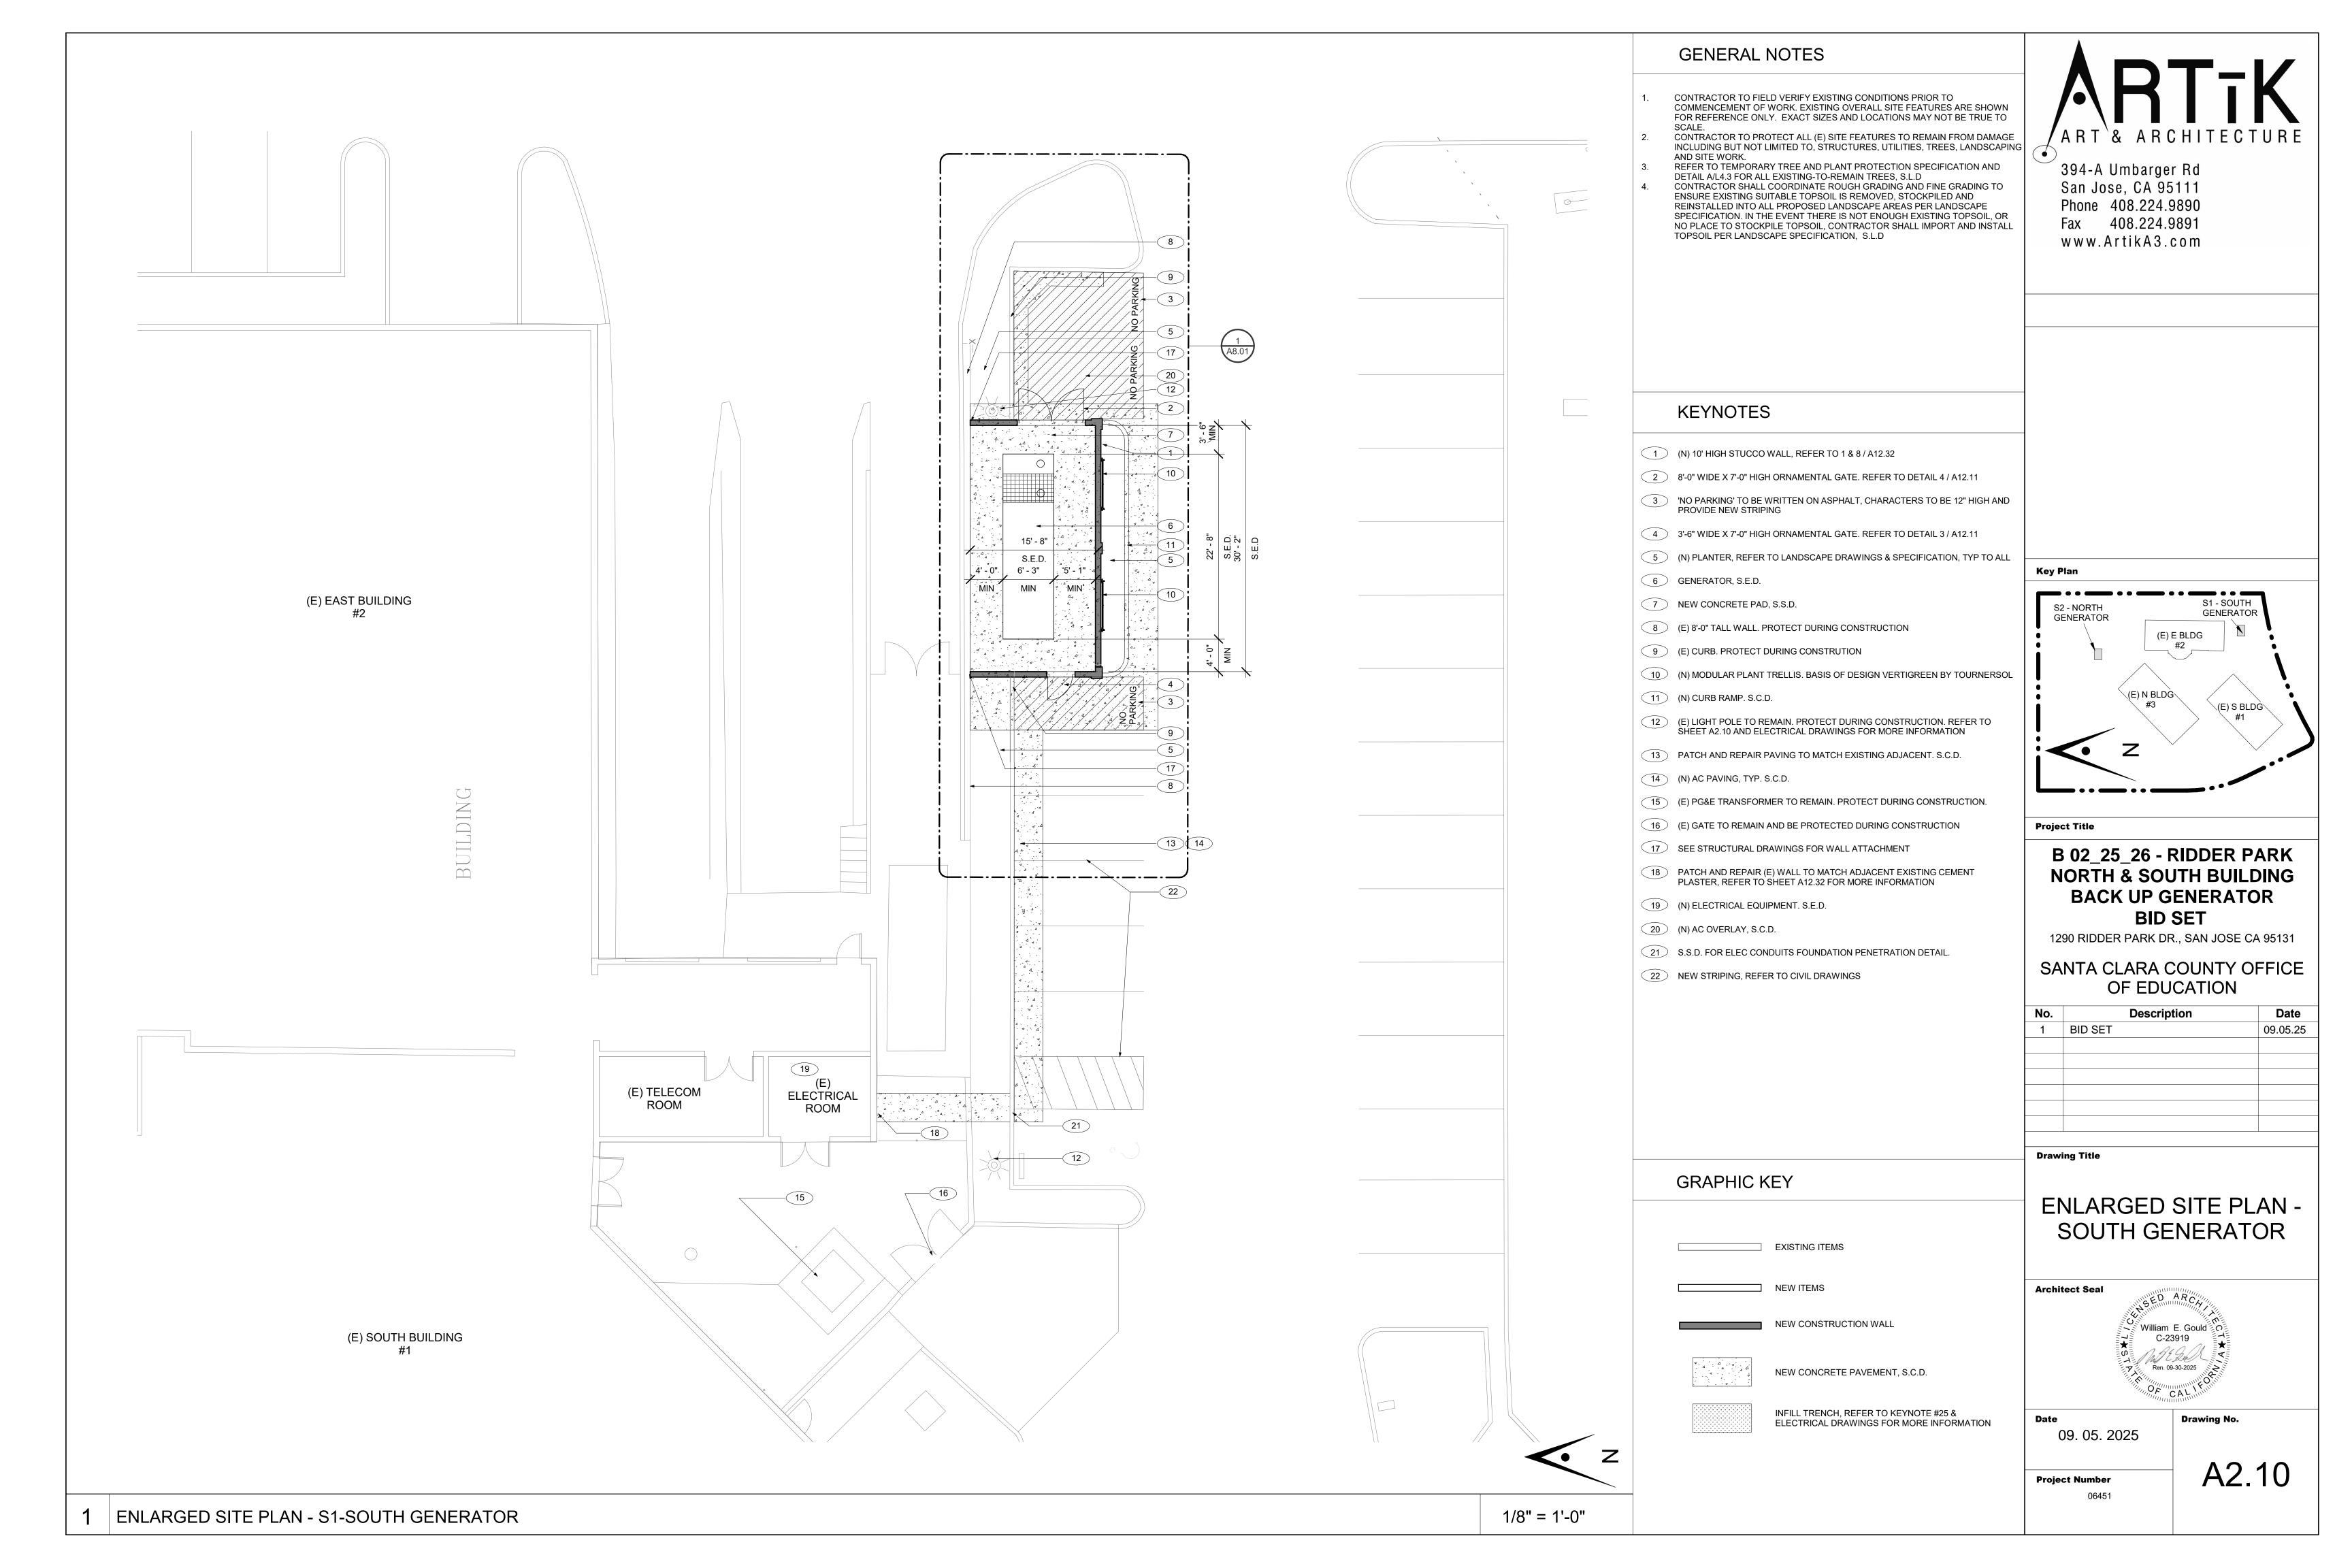


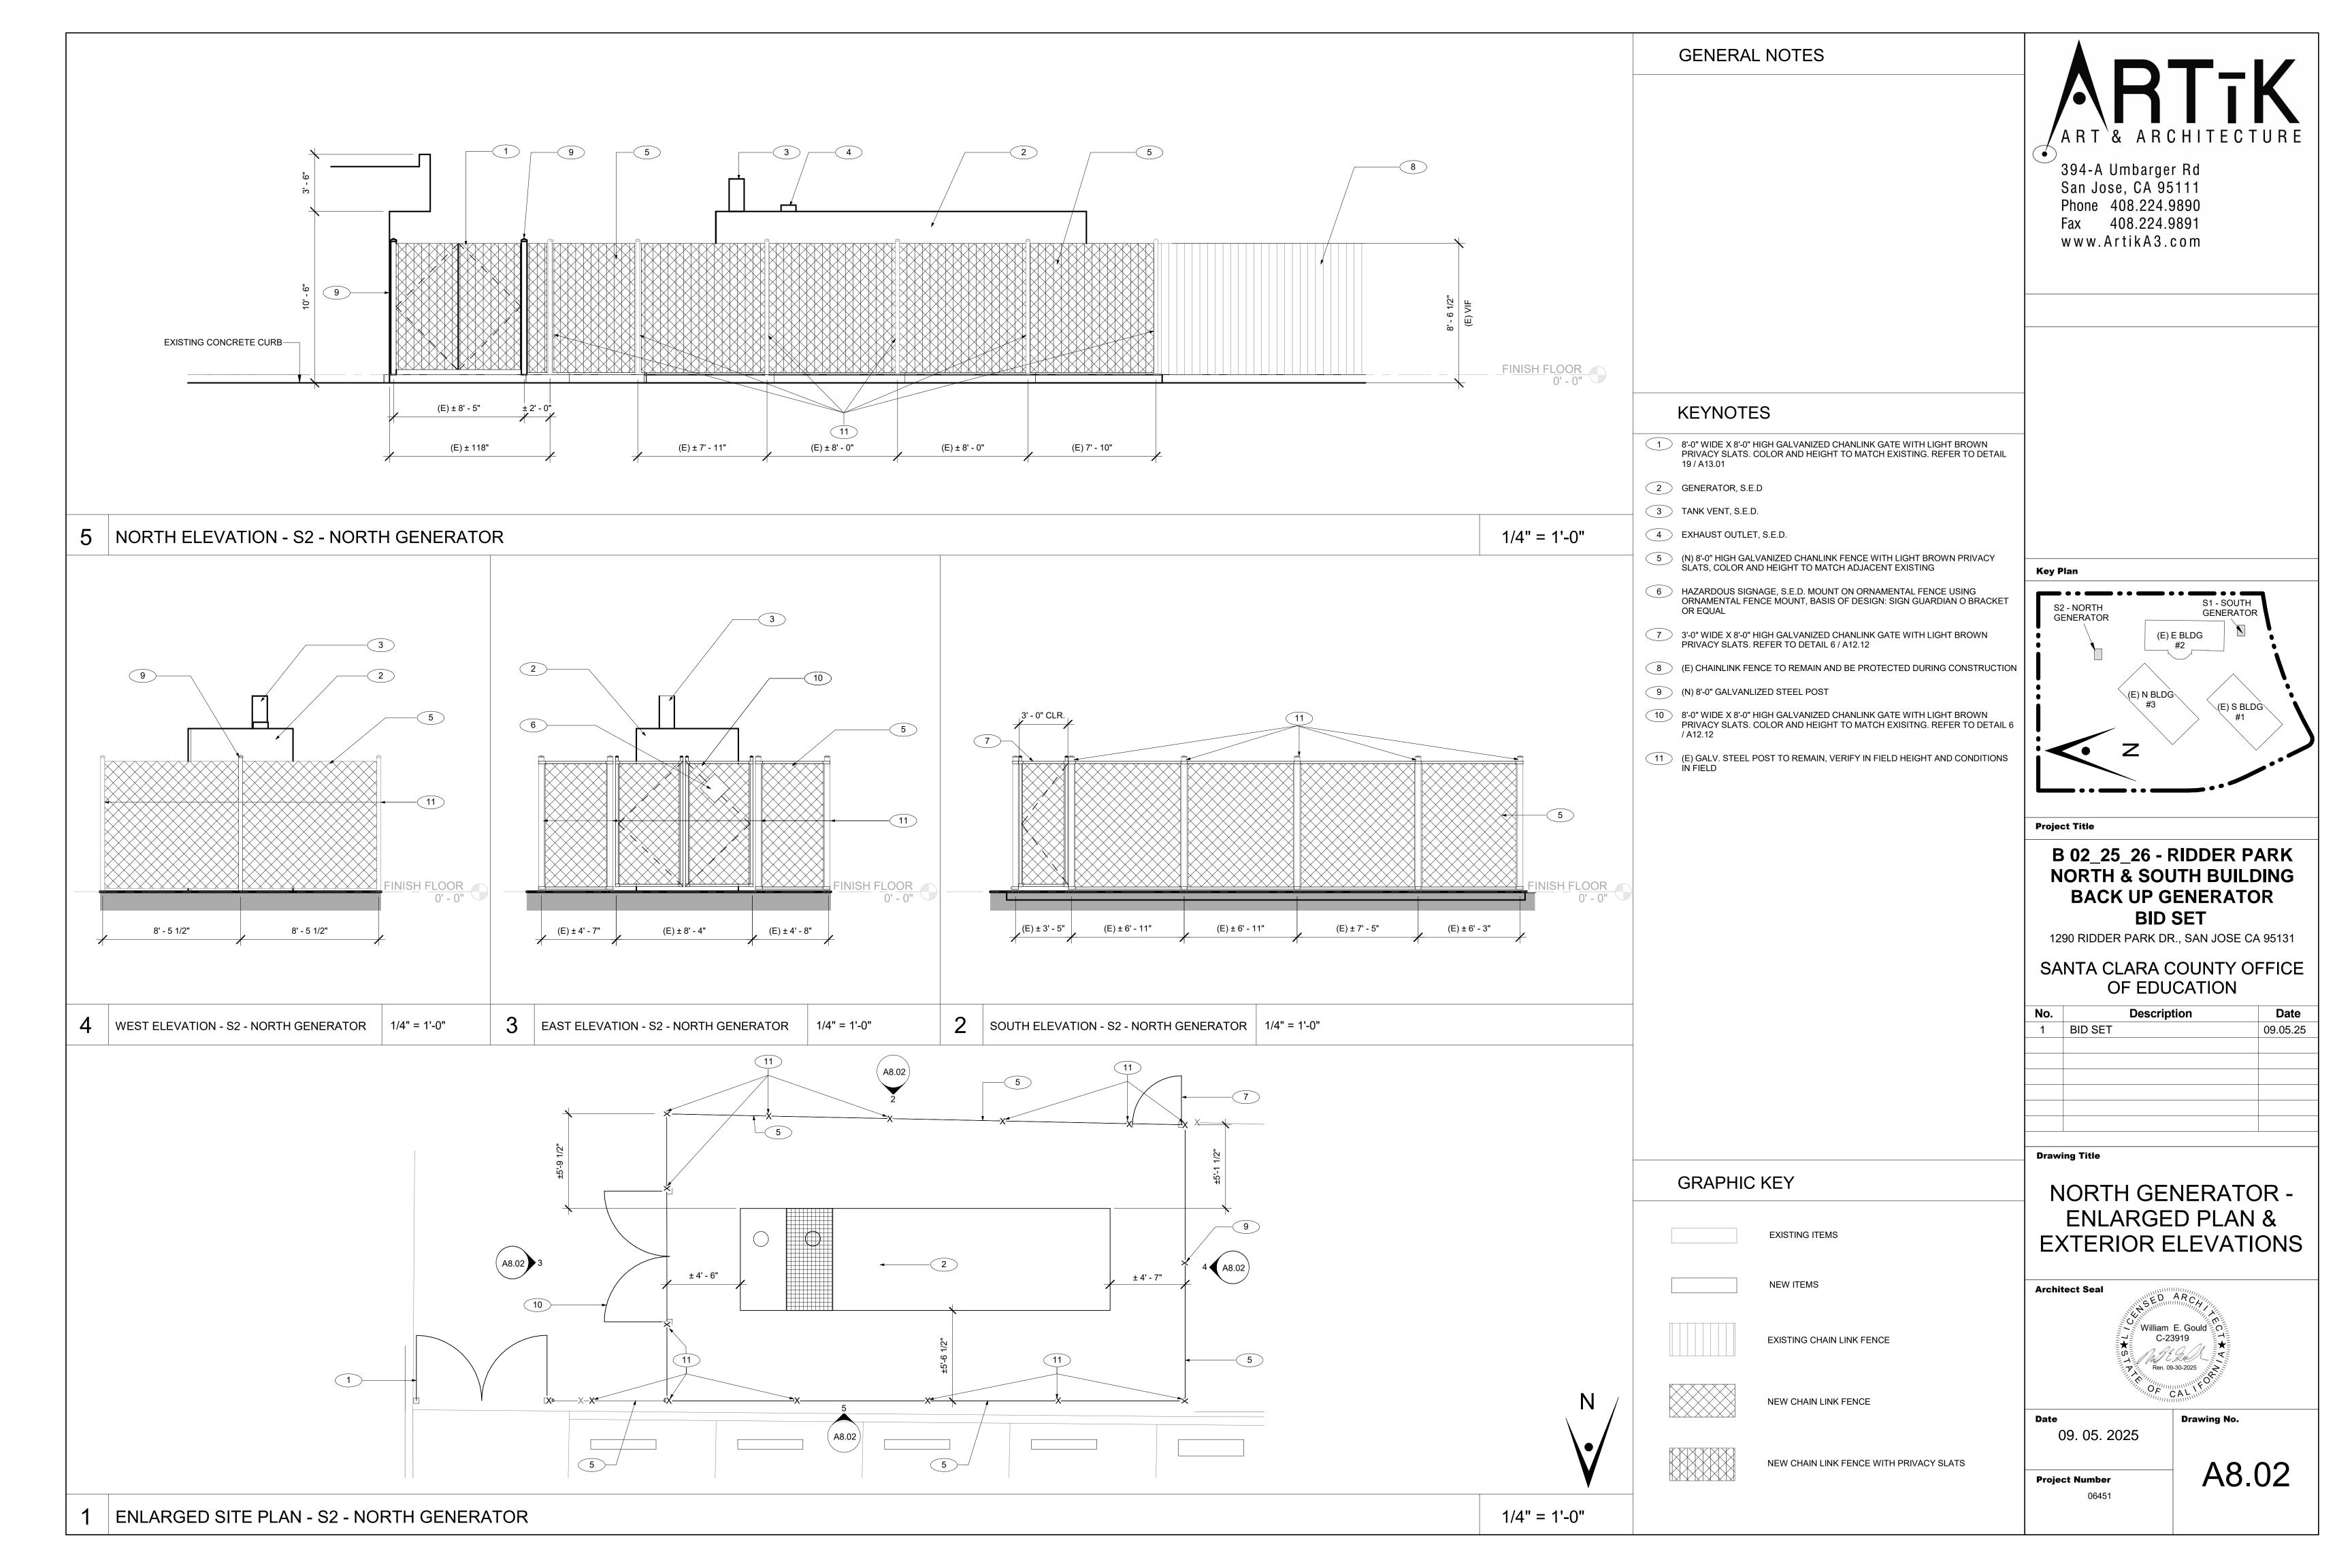

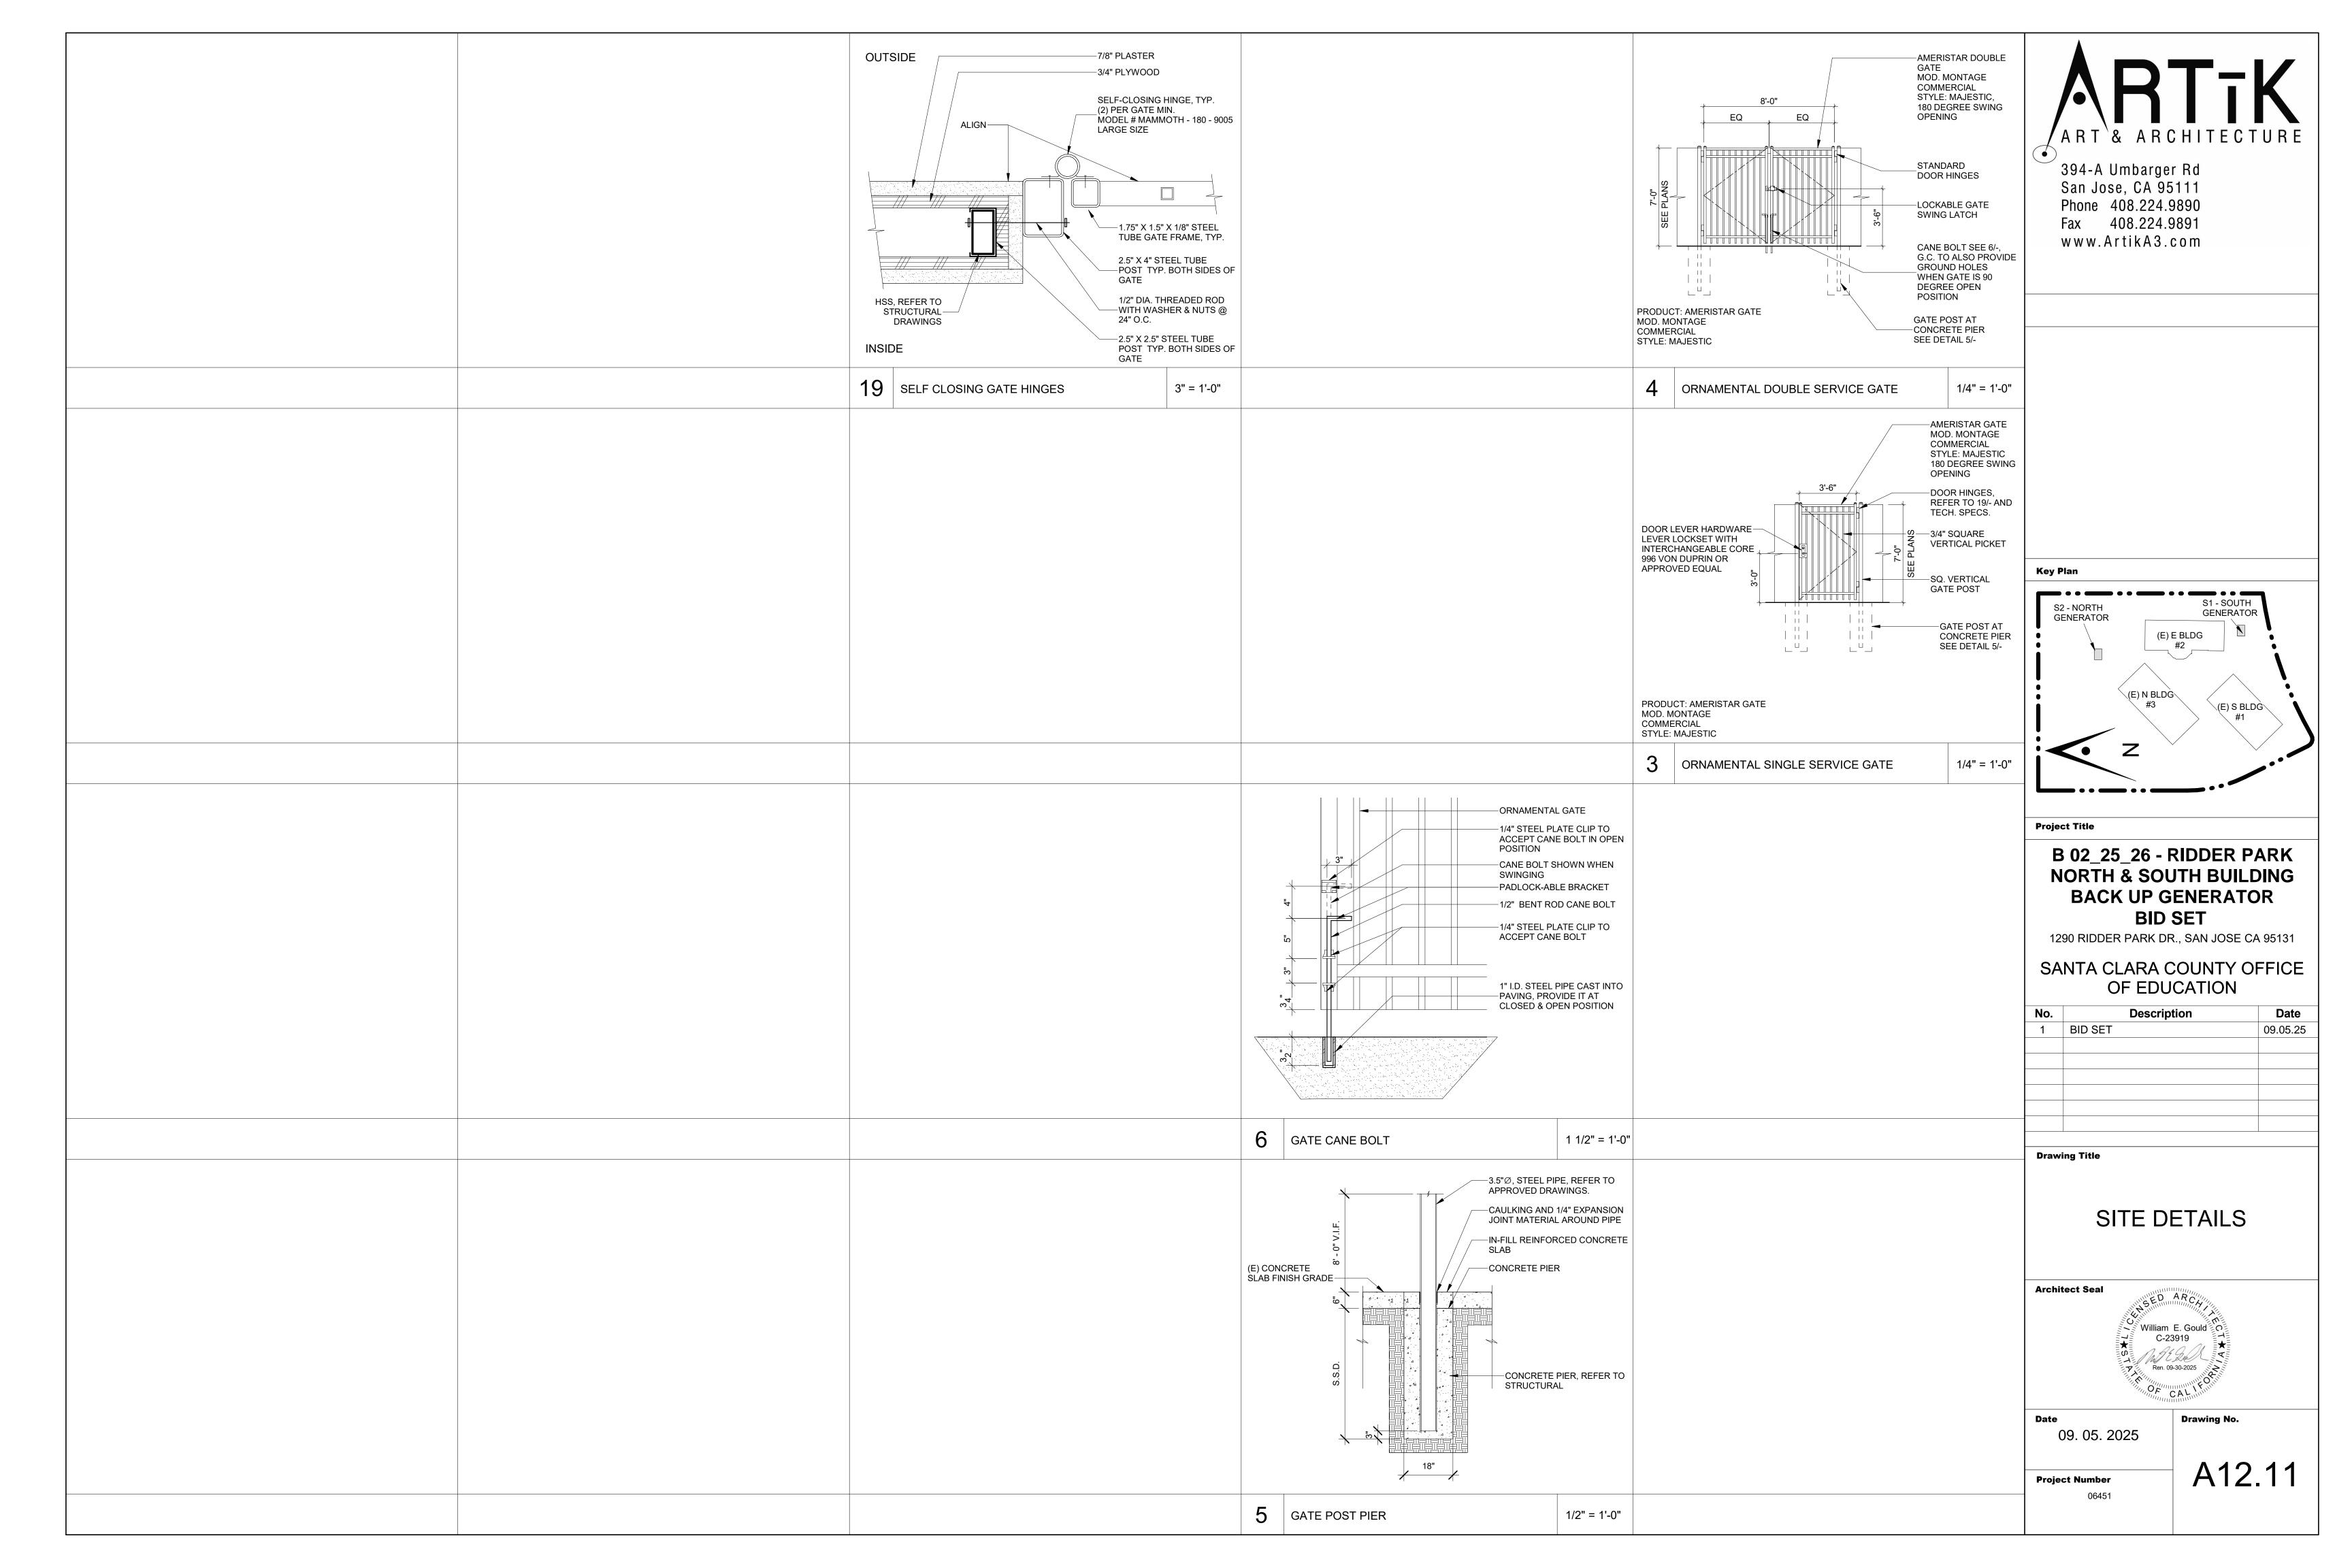

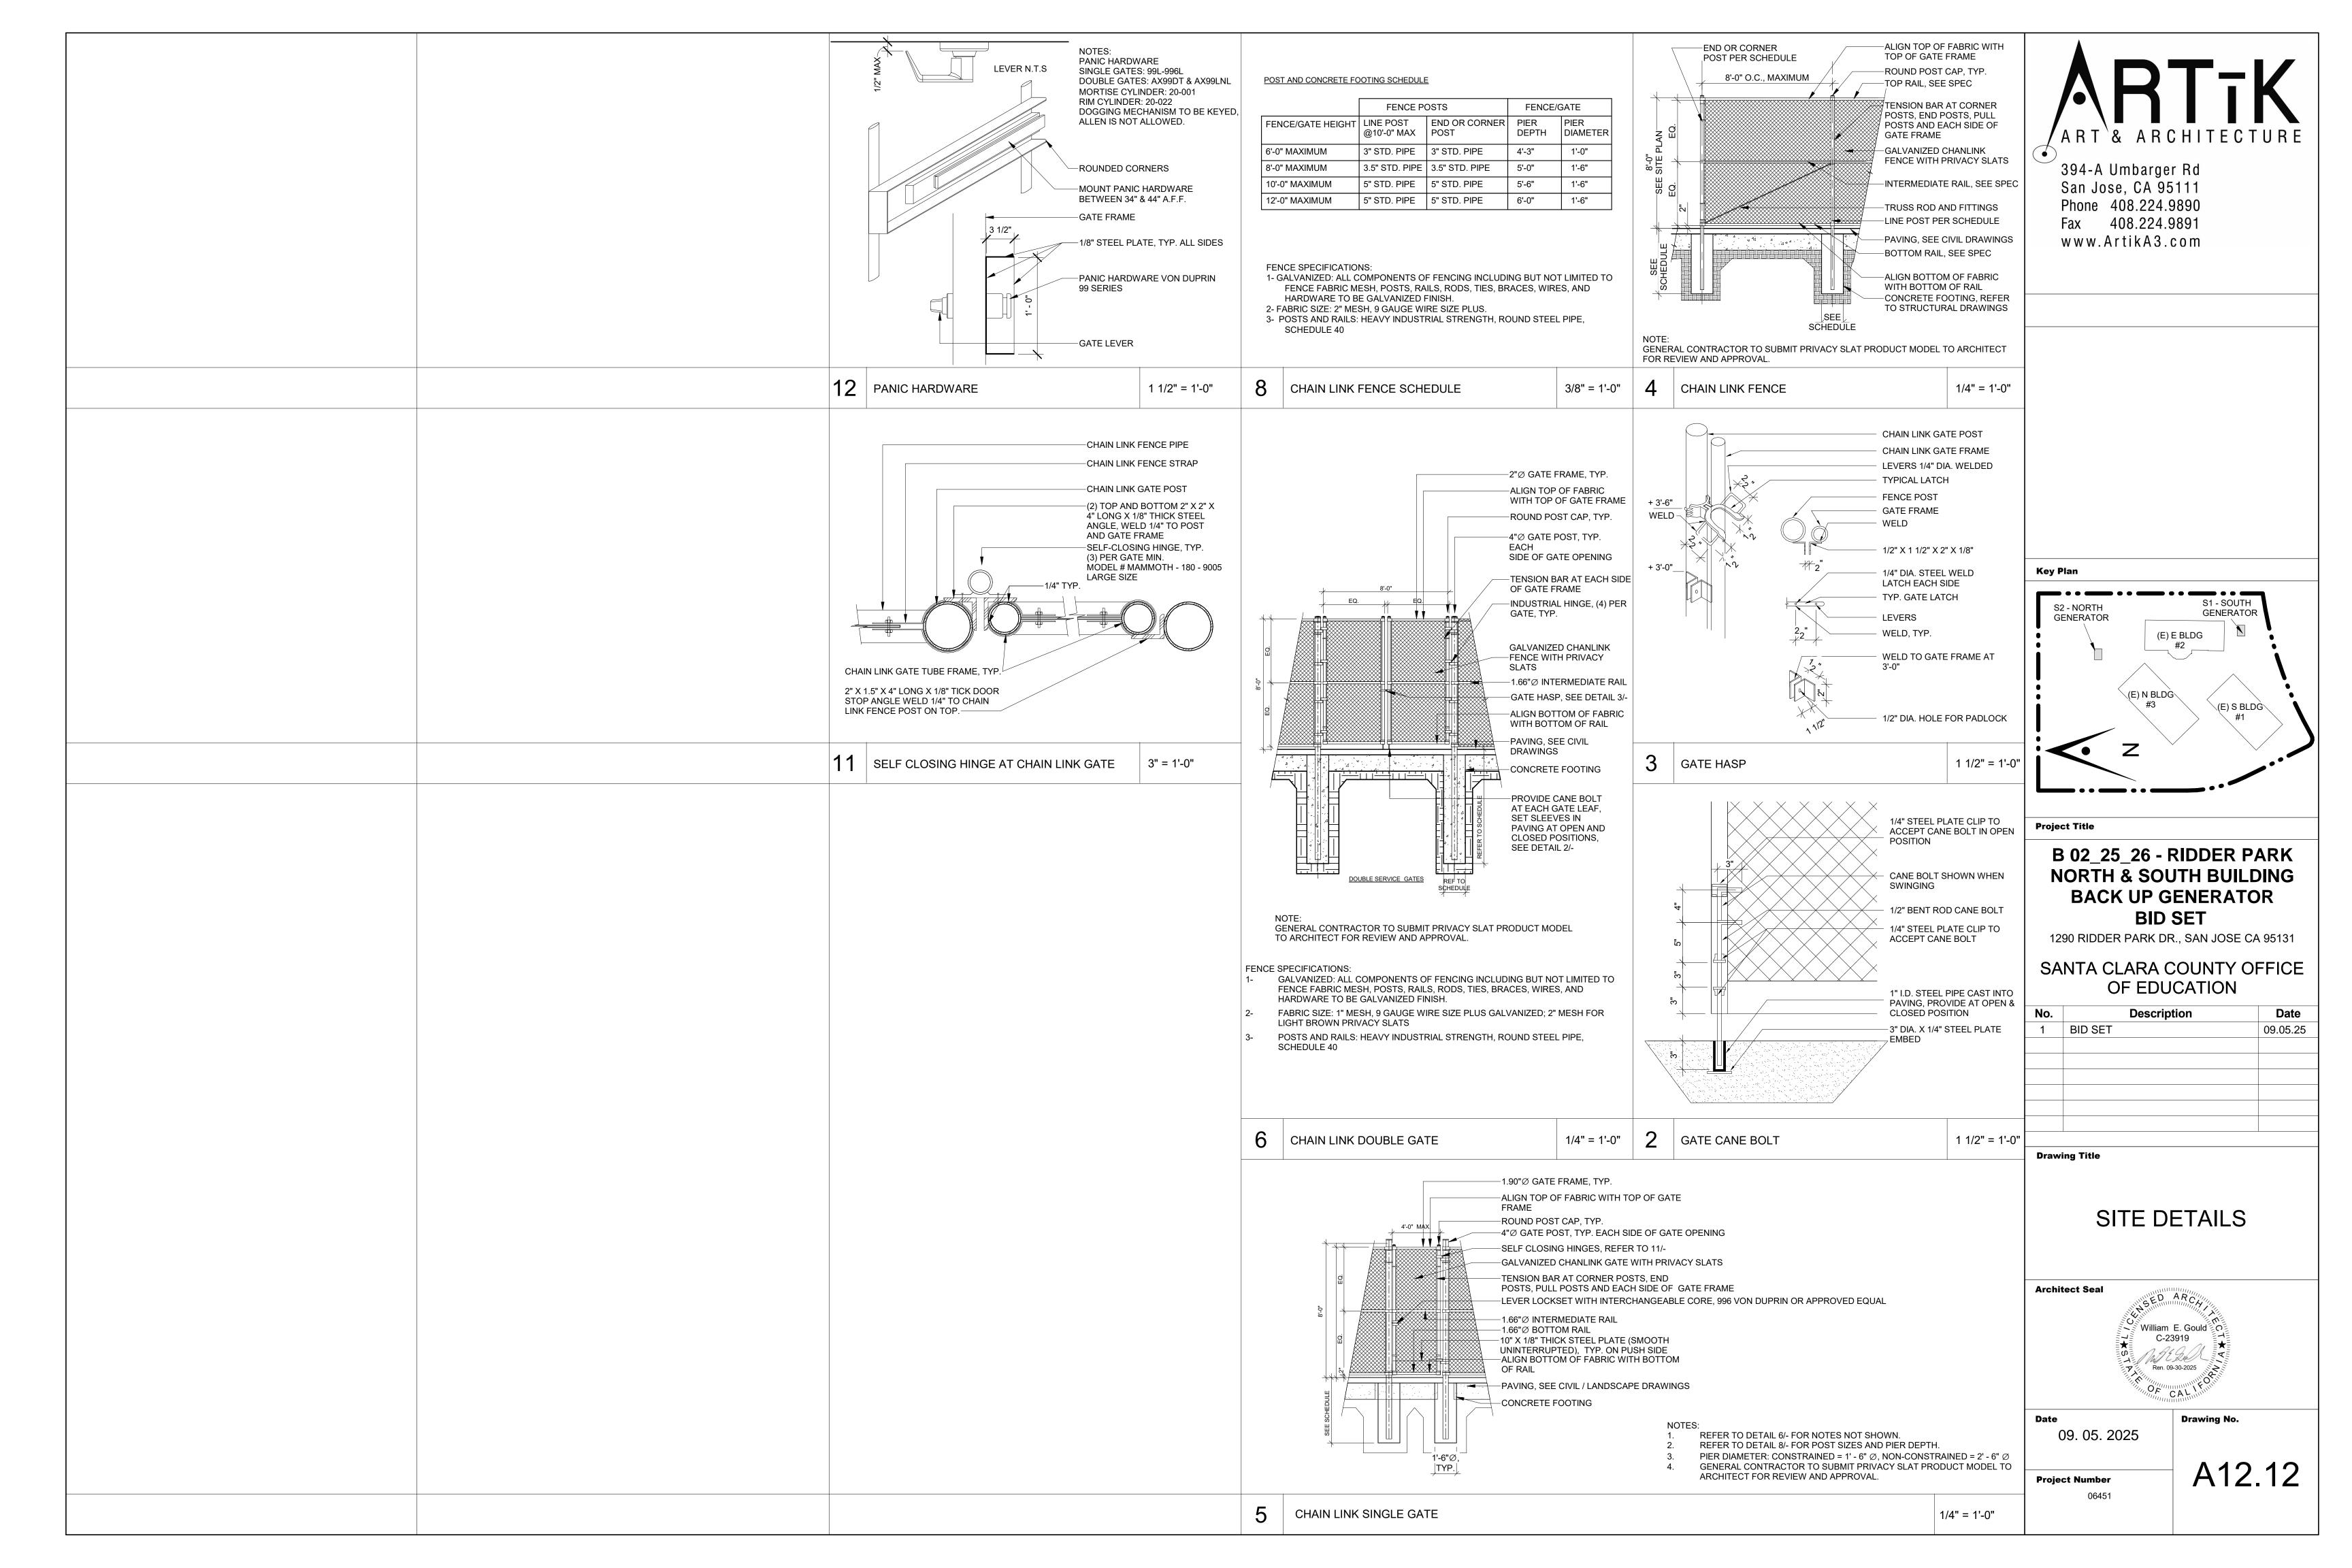

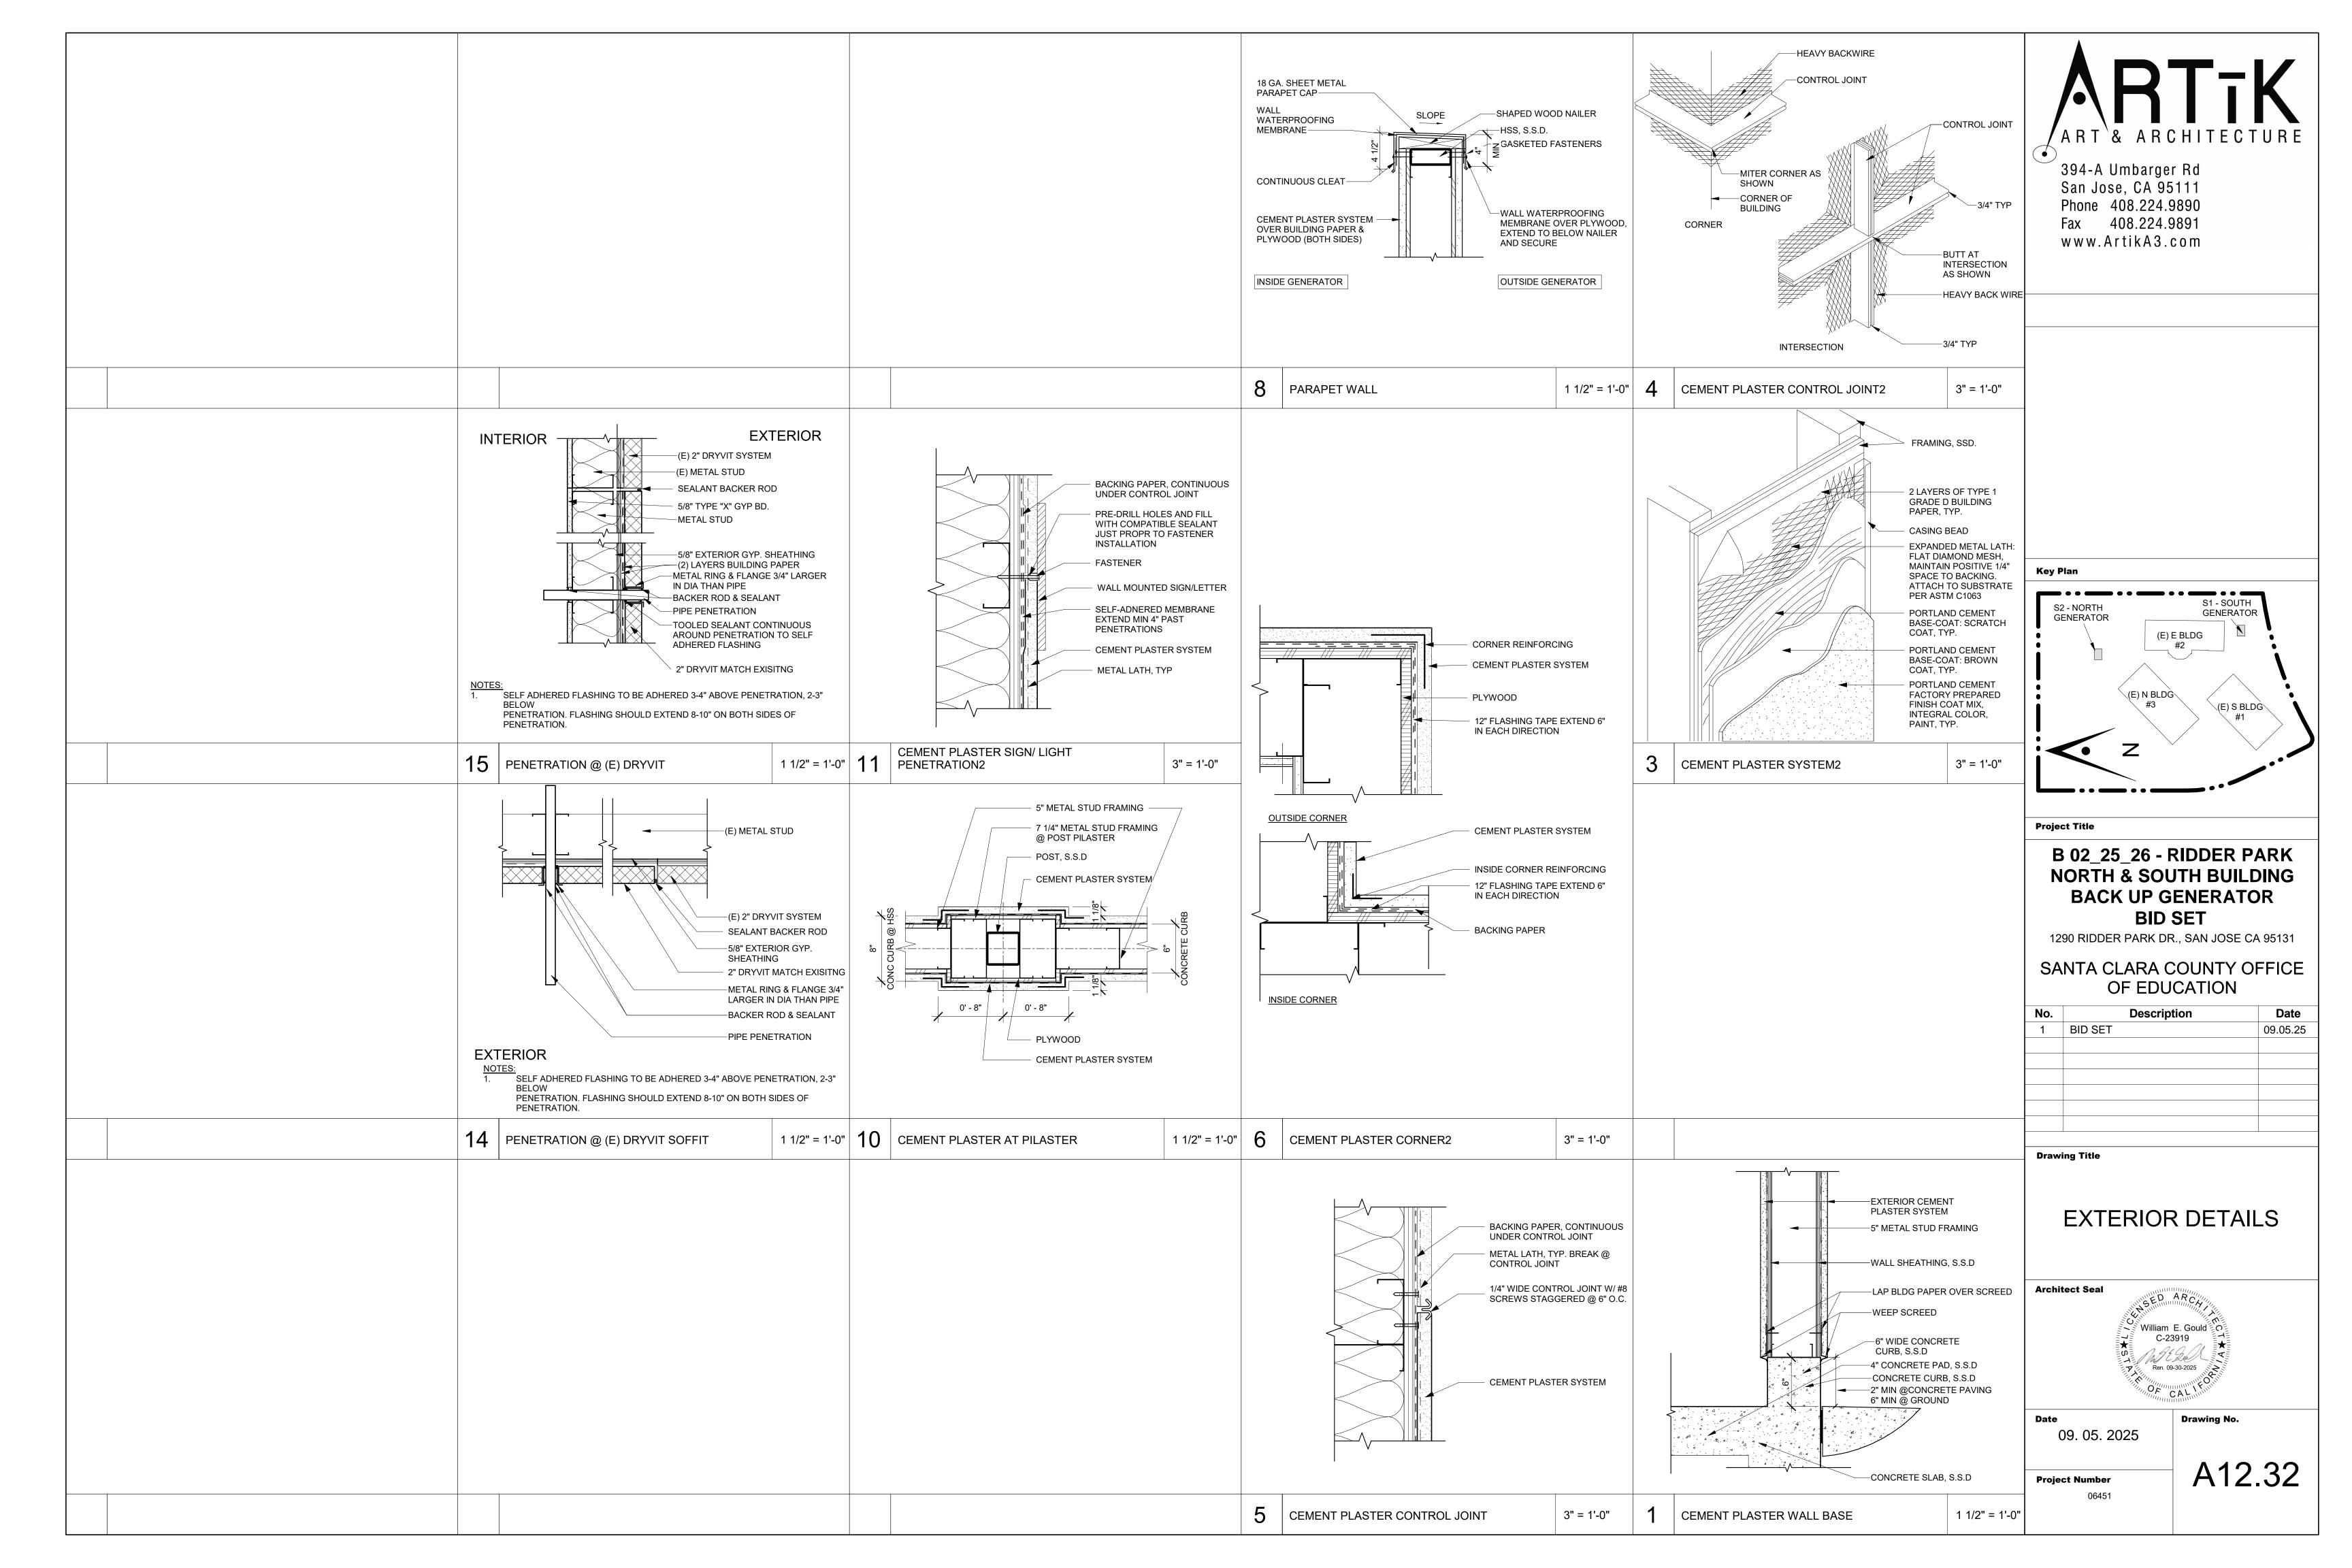

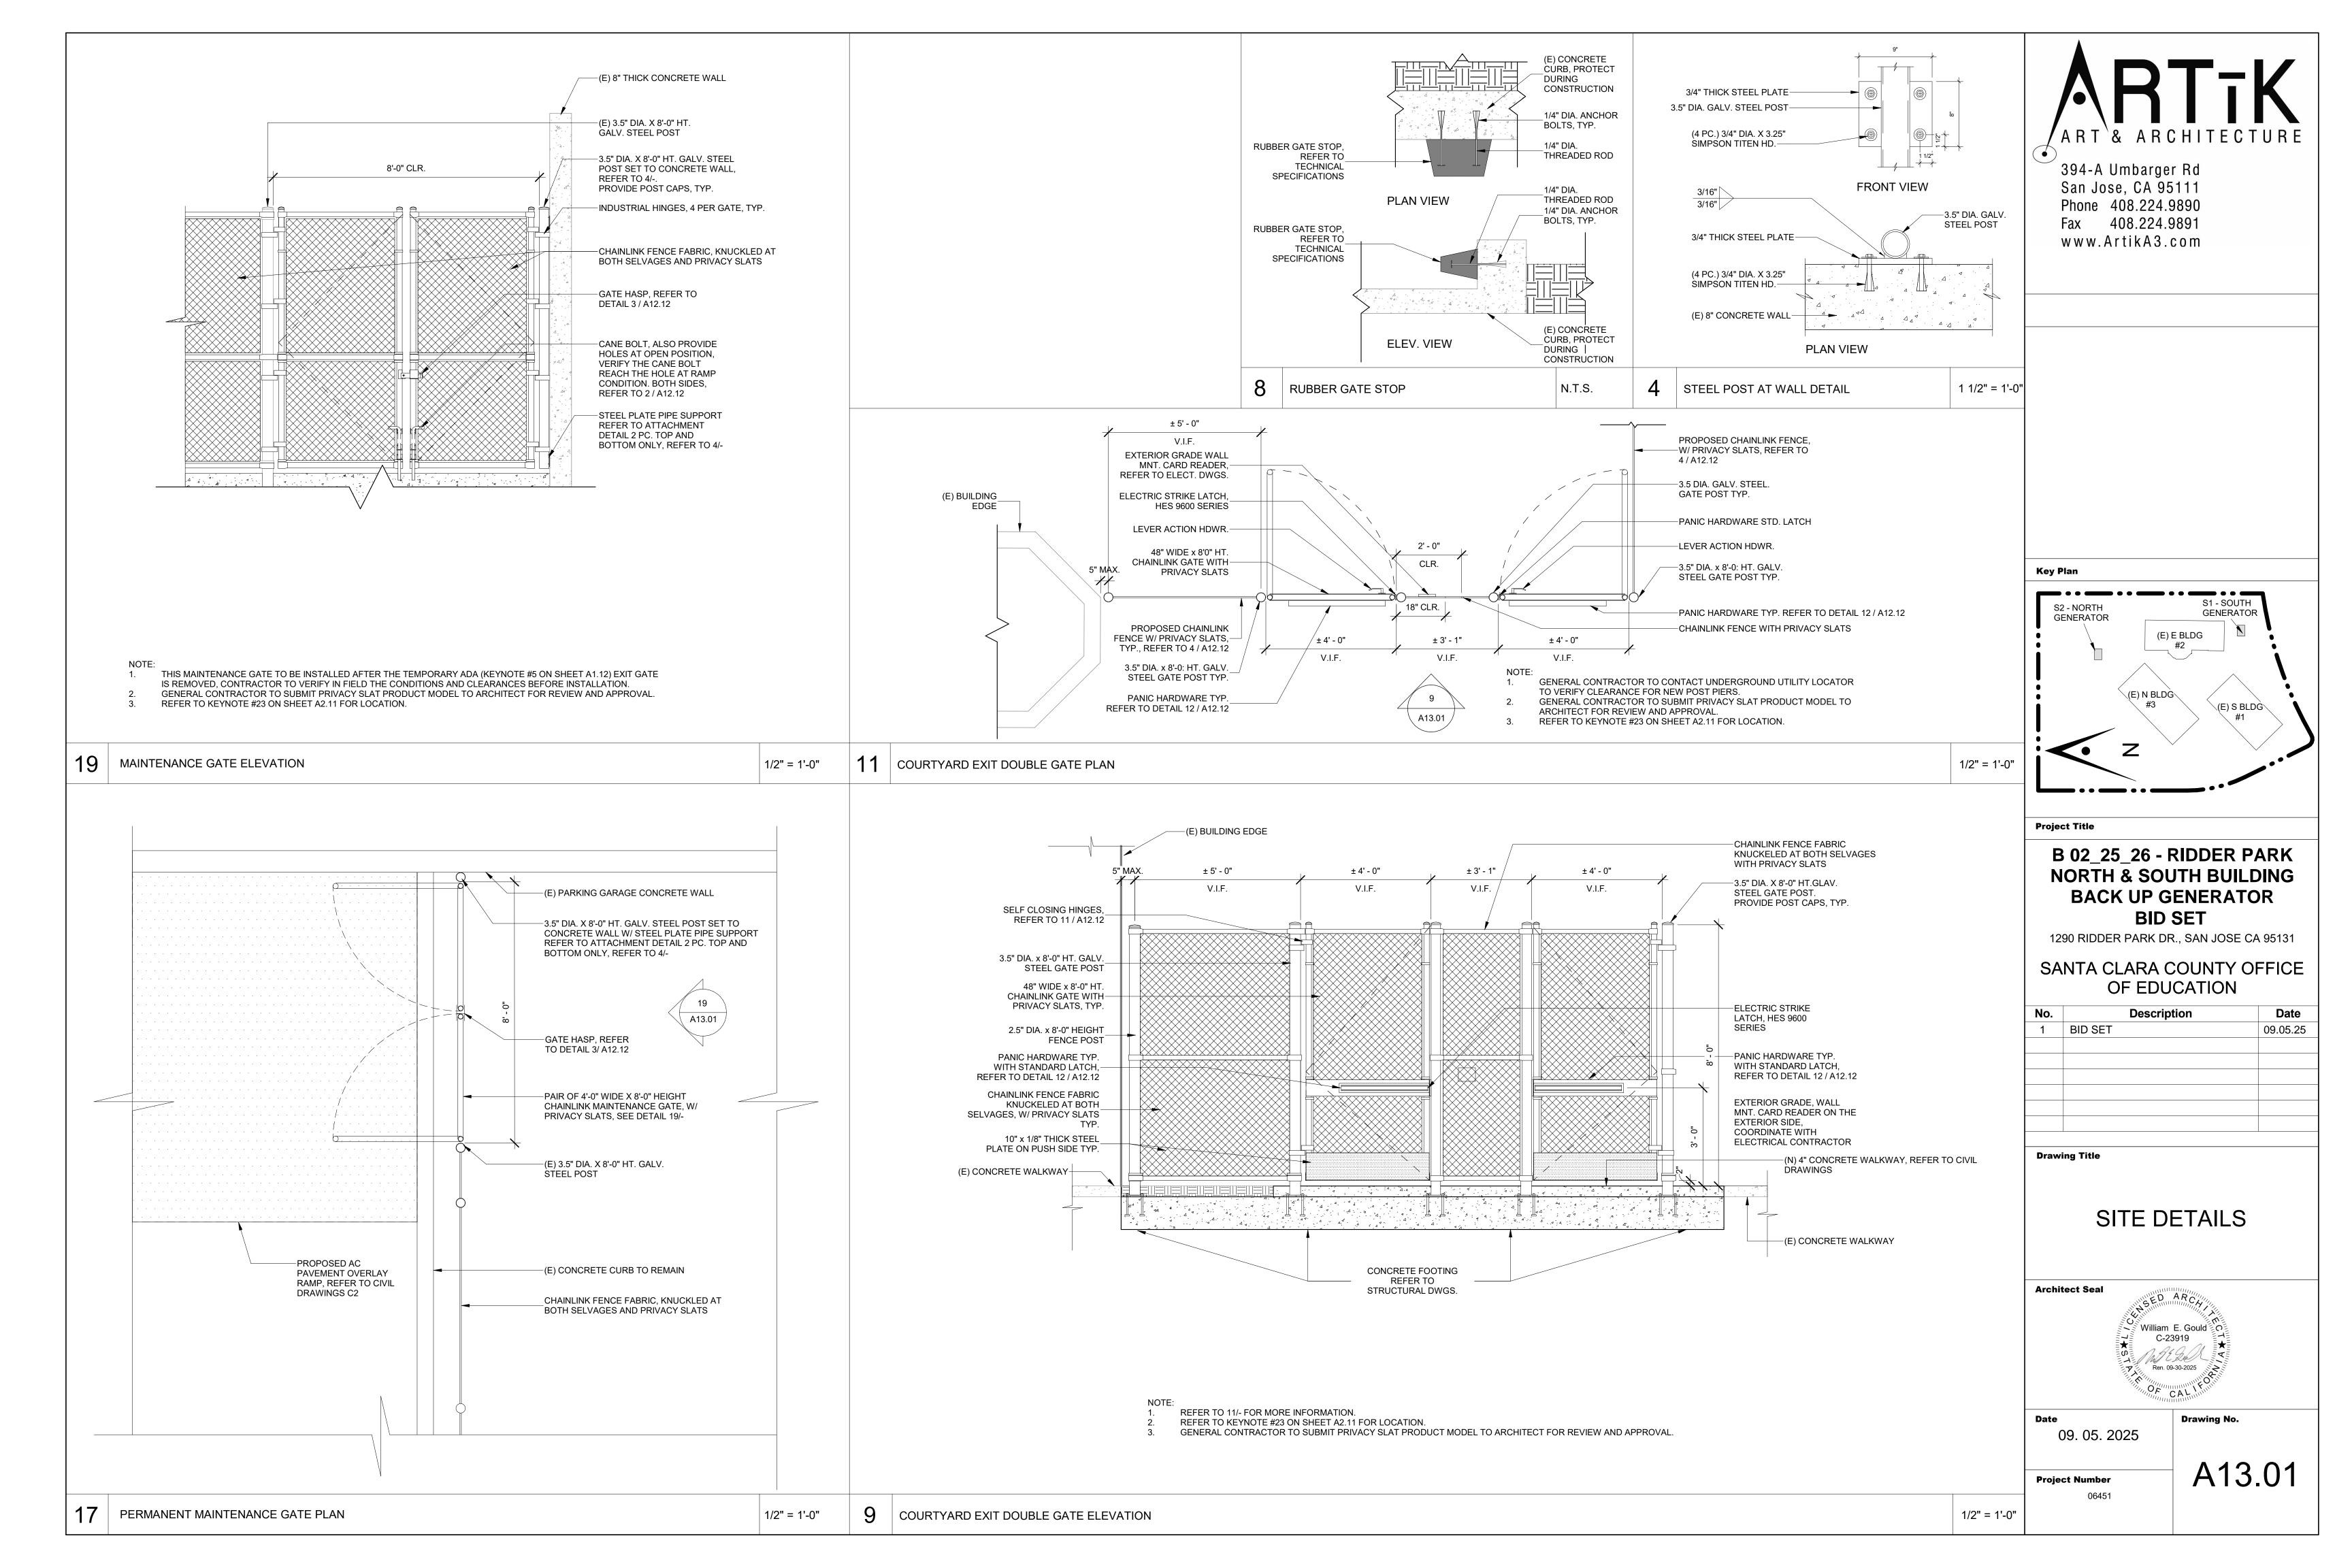

STRUCTURAL SPECIFICATIONS

COLD-FORMED METAL FRAMING

ALL COLD-FORMED METAL FRAMING SHALL BE AS MANUFACTURED BY CLARK STEEL (OR EQUAL) ASTM-A653 Fy = 33 KSI MINIMUM FOR 20 GAGE, & 18 GAGE Fy = 50 KSI FOR 16 GAGE OR BETTER

LIGHT GAGE METAL CONNECTORS

ALL LIGHT GAGE METAL CONNECTORS SHALL BE SIMPSON COMPANY STRONG TIE CONNECTORS,

UNLESS NOTED OTHERWISE ON THE DRAWINGS. CONCRETE

ALL CONCRETE SHALL HAVE PROPERTIES AS LISTED BELOW. MAXIMUM WATER-CEMENT RATIO, BY WEIGHT SHALL BE AS FOLLOWS:

	W/O FLY ASH	W/ UP TO 15%
	•	FLY ASH
5000 PSI CONCRETE AT 28 DAYS	.48	0.43
4000 PSI CONCRETE AT 28 DAYS	.55	0.5
3500 PSI CONCRETE AT 28 DAYS	.55	0.5
3000 PSI CONCRETE AT 28 DAYS	.55	0.5
2500 PSI CONCRETE AT 28 DAYS	.55	0.5
2000 PSI CONCRETE AT 28 DAYS	.67	0.60

APPROXIMATELY 3 OUNCES PER SACK OF CEMENT OF POZZOLITH 300R OR APPROVED EQUAL SHALL BE USED AS A WATER DISPERSING ADDITIVE. AT CONTRACTOR'S OPTION, AN AIR ENTRAINING AGENT CONFORMING TO THE LATEST REVISION OF ASTM SPECIFICATION C 260 MAY BE ADDED TO THE CONCRETE TO PROVIDE SPECIFIED AMOUNTS OF

CONCRETE ELEMENT	MIN. 28 DAY COMPRESSIVE STRENGTH	MAX. SIZE AGGREGATE (INCHES)	MAX. SLUMP	TOTAL AIF
SLAB ON GRADE	*3000	3/4	4	4%±1.5%

*2500 PSI USED FOR DESIGN, NO SPECIAL INSPECTION REQUIRED

REINFORCING STEEL

BARS FOR REINFORCING SHALL BE GRADE 60 DEFORMED BARS CONFORMING TO ASTM A-615 INCLUDING SUPPLEMENT S1. LAP SPLICES SHALL BE IN ACCORDANCE WITH ACI 318 UNLESS NOTED OTHERWISE ON THE PLANS.

SLAB MEMBRANE - 15 MIL. MOISTOP MEMBRANE

ADHESIVE ANCHORING FOR CONCRETE

EPOXY ADHESIVE SHALL BE SIMPSON SET-XP EPOXY ADHESIVE ICC REPORT ESR-2508. THE PROPORTIONS SHALL BE AS RECOMMENDED BY THE MANUFACTURER FOR THE CONDITION AND USE. PREPARATION OF CONCRETE INCLUDING DRILLING OF HOLES FOR ANCHORS AS WELL AS EPOXY ANCHOR INSTALLATION SHALL BE AS RECOMMENDED BY THE MANUFACTURER.

STRUCTURAL STEEL AND MISCELLANEOUS IRON

ALL STRUCTURAL STEEL AND MISCELLANEOUS IRON SHALL RECEIVE SHOP PRIME COAT. INDIVIDUAL SPECIFICATIONS ARE AS FOLLOWS.

1.) HOLLOW STRUCTURAL STEEL AND TUBE STEEL - ASTM A500, GRADE B, Fy = 46ksi 2.) <u>STEEL PIPE</u> – ASTM A53, TYPE E OR S, GRADE B, w/ SULFUR NOT EXCEEDING .05%, Fy = 35ksi

MACHINE BOLTS, ANCHOR BOLTS AND STUDS

ASTM A307 THREADED RODS

ASTM F1554 GRADE A36

ALL WELDING SHALL BE PERFORMED BY CERTIFIED WELDERS PER AWS "STANDARD QUALIFICATION PROCEDURE" TO PERFORM THE TYPE OF WORK REQUIRED. ALL WELDING SHALL BE IN ACCORDANCE WITH AWS WELDING CODE. ARC WELDING ELECTRODES SHALL BE E70 SERIES. WELDING SHALL BE INSPECTED AS REQUIRED BY THE CALIFORNIA BUILDING CODE.

CONSTRUCTION LIABILITY

CONSTRUCTION CONTRACTOR AND HIS SUBCONTRACTORS AGREE THAT IN ACCORDANCE WITH GENERALLY ACCEPTED CONSTRUCTION PRACTICES, CONSTRUCTION CONTRACTOR AND HIS SUBCONTRACTORS WILL BE REQUIRED TO ASSUME SOLE AND COMPLETE RESPONSIBILITY FOR JOB SITE CONDITIONS DURING THE COURSE OF CONSTRUCTION OF THE PROJECT, INCLUDING SAFETY OF ALL PERSONS AND PROPERTY: THAT THIS REQUIREMENT SHALL BE MADE TO APPLY CONTINUOUSLY AND NOT LIMITED TO NORMAL WORKING HOURS, AND CONSTRUCTION CONTRACTOR AND HIS SUBCONTRACTORS FURTHER AGREE TO DEFEND, INDEMNIFY AND HOLD DESIGN PROFESSIONAL HARMLESS FROM ANY AND ALL LIABILITY, REAL OR ALLEGED, IN CONNECTION WITH THE PERFORMANCE OF WORK ON THIS PROJECT, EXCEPT LIABILITY ARISING FROM THE SOLE NEGLIGENCE OF DESIGN PROFESSIONAL.

EXISTING CONDITIONS

MINIMUM REQUIRED FASTENING

(UNLESS DETAILED OTHERWISE)

(2)-#10 SELF-DRILLING SCREWS

THE CONTRACTOR OR SUBCONTRACTOR SHALL FIELD VERIFY ALL EXISTING CONDITIONS PRIOR TO BEGINNING CONSTRUCTION AND OR ORDERING MATERIAL. ANY DISCREPANCIES DISCOVERED SHALL BE BROUGHT TO THE ATTENTION OF THE ENGINEER IMMEDIATELY.

3/8" MAX GAP BETWEEN—

STUD AND TOP PLATE AT

BEARING WALLS

16 GAGE TRACK-

#10 SELF-DRILLING

SPECIAL INSPECTIONS

THE OWNER SHALL EMPLOY A SPECIAL INSPECTOR DURING CONSTRUCTION ON THE FOLLOWING TYPES OF WORK:

WELDING DUCTILE MOMENT-RESISTING STEEL FRAMES. AS REQUIRED BY THE APPLICABLE SECTION OF THE 2013 C.B.C.

- ALL STRUCTURAL WELDING, INCLUDING WELDING OF REINFORCING STEEL.
- - 1. WELDING DONE IN A FABRICATOR'S SHOP, APPROVED BY THE CITY BUILDING OFFICIAL.
 - 2. SINGLE PASS FILLET WELDS MAY HAVE PERIODIC INSPECTION PER C.B.C. NOTED OTHERWISE UNLESS ON THE CONTRACT DRAWINGS.

ADHESIVE ANCHORS

DURING ALL ADHESIVE ANCHORING INSTALLATIONS.

EXPANSION ANCHORS

- THE SPECIAL INSPECTOR MUST BE ON THE JOB SITE CONTINUOUSLY DURING ANCHOR INSTALLATION TO VERIFY ANCHOR TYPE, ANCHOR DIMENSIONS, CONCRETE TYPE, CONCRETE COMPRESSIVE STRENGTH, HOLE DIMENSIONS, HOLE CLEANING PROCEDURES, ANCHOR SPACING, EDGE DISTANCES, CONCRETE THICKNESS, ANCHOR EMBEDMENT AND TIGHTENING TORQUE. SPECIAL INSPECTOR
- THE SPECIAL INSPECTOR SHALL BE A QUALIFIED PERSON WHO SHALL DEMONSTRATE HIS COMPETENCE, TO THE SATISFACTION OF THE BUILDING OFFICIAL, FOR INSPECTION OF A PARTICULAR TYPE OF CONSTRUCTION OR OPERATION REQUIRING SPECIAL INSPECTION.

DUTIES AND RESPONSIBILITIES OF THE SPECIAL INSPECTOR

- THE SPECIAL INSPECTOR SHALL OBSERVE THE WORK ASSIGNED FOR CONFORMANCE WITH THE APPLICABLE DESIGN DRAWINGS AND SPECIFICATIONS.
- THE SPECIAL INSPECTOR SHALL FURNISH INSPECTION REPORTS TO THE BUILDING OFFICIAL, THE ENGINEER OR ARCHITECT OF RECORD, AND OTHER DESIGNATED PERSONS. ALL DISCREPANCIES SHALL BE BROUGHT TO THE IMMEDIATE ATTENTION OF THE CONTRACTOR FOR CORRECTION, THEN, IF UNCORRECTED, THE PROPER DESIGN AUTHORITY AND TO THE BUILDING OFFICIAL.
- THE SPECIAL INSPECTOR SHALL SUBMIT A FINAL SIGNED REPORT STATING WHETHER THE WORK REQUIRING SPECIAL INSPECTION WAS, TO THE BEST OF HIS KNOWLEDGE, IN CONFORMANCE WITH THE APPROVED PLANS AND SPECIFICATIONS AND THE APPLICABLE WORKMANSHIP PROVISION OF THIS CODE.

SHEET	CONTENT
S0.0	STRUCTURAL SPECIFICATIONS ABBREVIATIONS LEGEND SYMBOLS LEGEND TABLE OF CONTENTS
S1.0	NORTH GENERATOR FOUNDATION PLA SOUTH GENERATOR FOUNDATION PLA DETAILS
S1.1	PARTIAL FENCE PLAN DETAIL
S	YMBOLS LEGEND
SYMBOL	DESCRIPTION
1· S2.1·	-Detail No. -Sheet Location
^	-View Direction
1. 50.1,	Section/Elevation No. Sheet Location
	Indicates Degree of Slope
1/4 SLOPE	Indicates Sloped Beam, Slab, or Deck. Arrowhead indicates direction.
6'-0"±	Indicates estimated dimension. For Exact Dimension see Architect
G	Indicates 2x with strut from roof to wall below or from ceiling to roof above
	Indicates Field Weld, Shop Weld when not shown.
1/4	⟨TYP. Weld Notes
	- Weld Type - Weld Size - Weld all sides
	Refer to AISC, Latest Edition, for All Weld Types & Symbols
<u> </u>	-Revision Number
	-Affected Region due to Current Revision.





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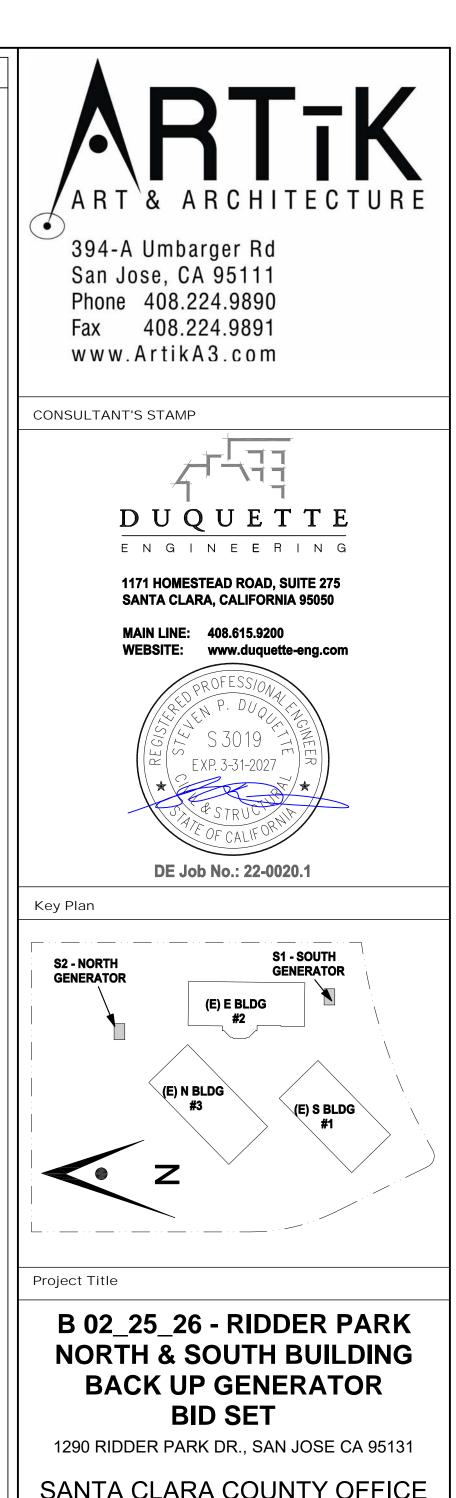
ABBREVIATIONS

Architect or Architectual

Aluminum

A.B.

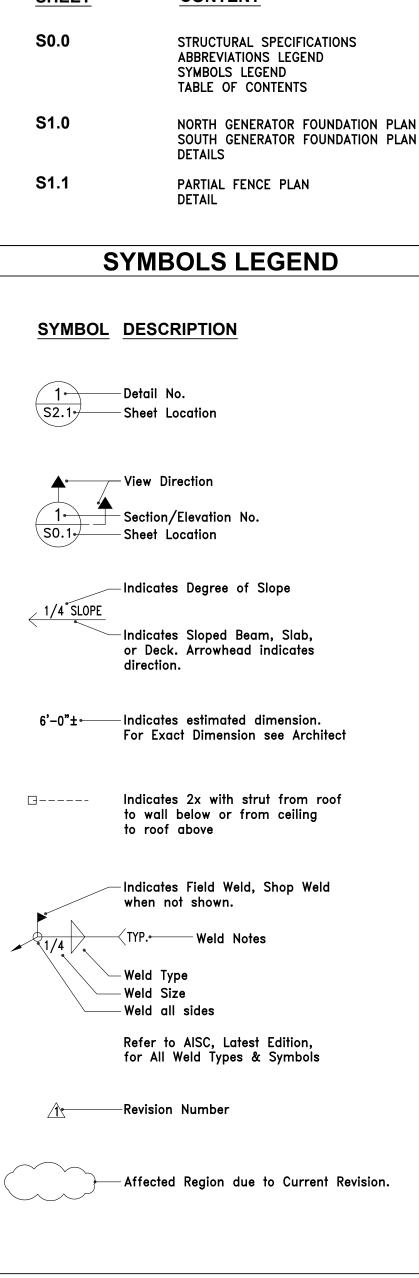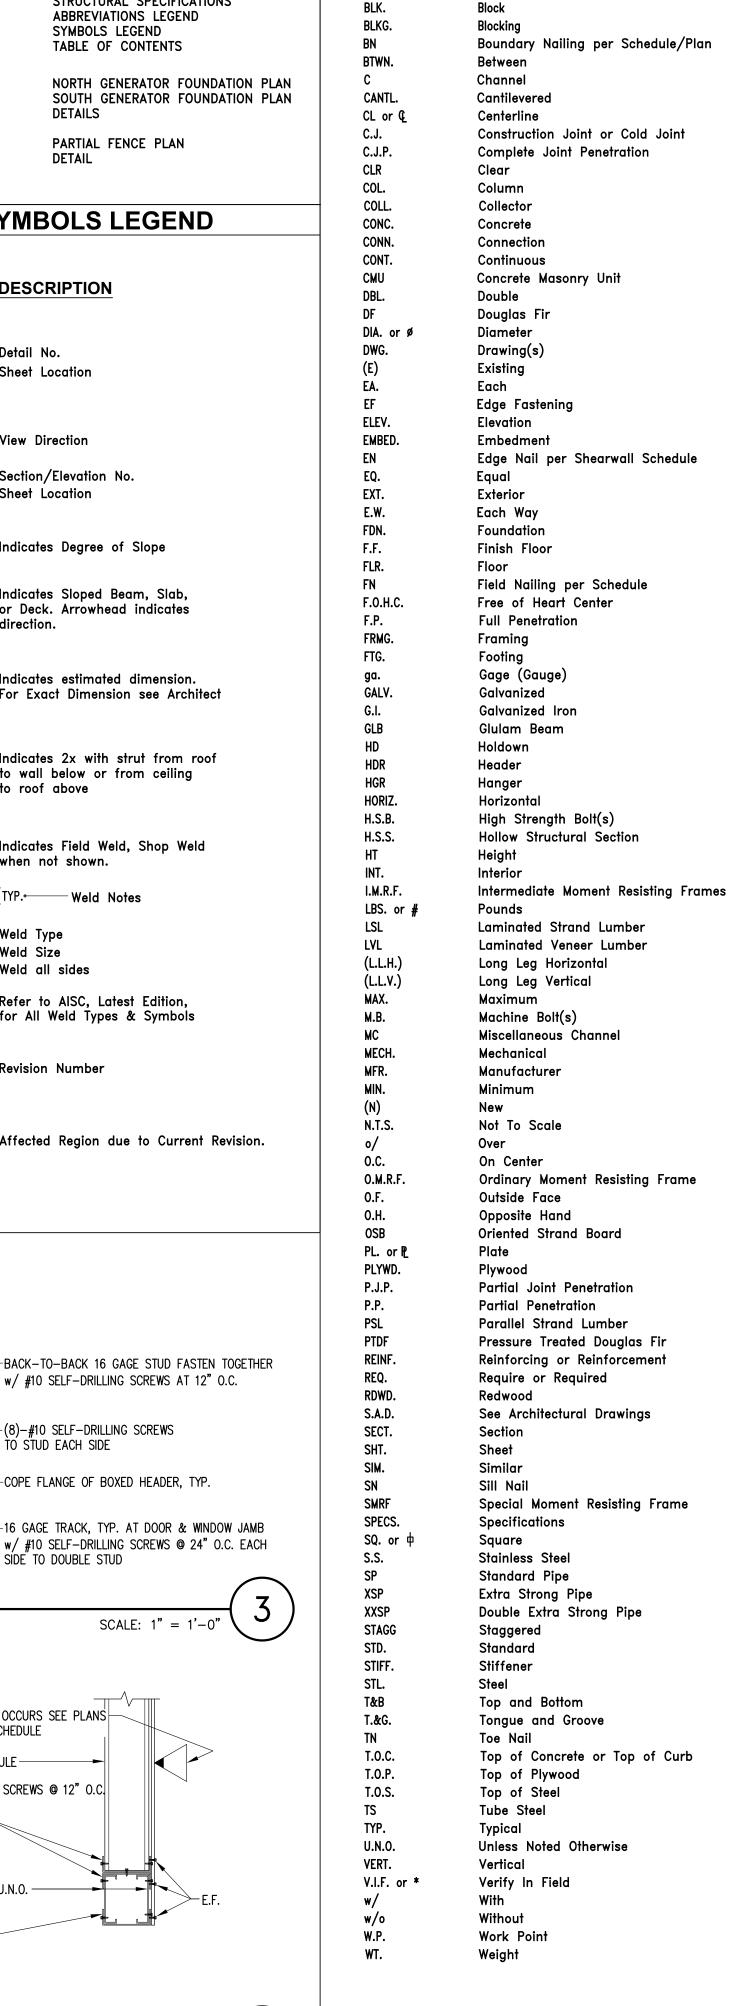ARCH.



SANTA CLARA COUNTY OFFICE OF EDUCATION

No.	Description	Date
1	-BID SET	0 9.05.25

STRUCTURAL SPECS. **ABBREVIATIONS** SYMBOLS LEGEND TABLE OF CONTENTS

Architect Seal

Drawing No. 09. 05. 2025 **S0.0** Project Number


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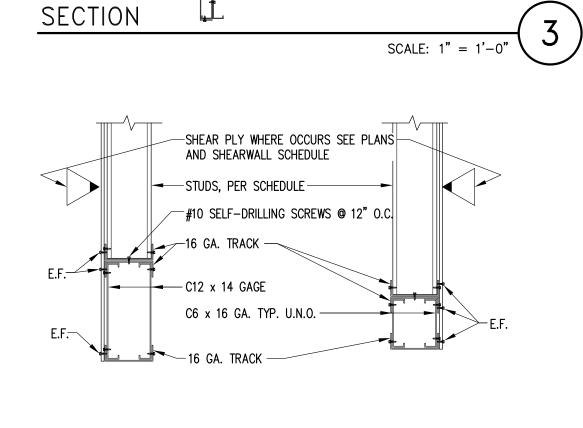
BLOCKING TO TRACK OR HEADER (3)-10 SELF-DRILLING SCREWS TRACK AT BOXED HEADER #10 SELF-DRILLING SCREWS @ 12" O.C. EACH FLANGE TRACK LEDGER TO STUD (4)-#10 SELF-DRILLING SCREWS EACH STUD BACK-TO-BACK MEMBERS #10 SELF-DRILLING SCREWS STAGGERED @ 12" O.C. TRACK TO STUD (2)-#10 SELF-DRILLING SCREWS TOP & BOTTOM JOIST PARALLEL TO TRACK #10 SELF-DRILLING SCREWS @ 12" O.C. SIMPSON ANGLES & CONNECTORS SEE SIMPSON SPECIFICATIONS 1/2" MINIMUM EDGE DISTANCE, TYPICAL -#10 SCREW 3 FULL THREAD MIN.-MINIMUM FASTENING SCHEDULE

FASTENING SCHEDULE

FASTENED CONNECTION DESCRIPTION

JOISTS TO TRACK



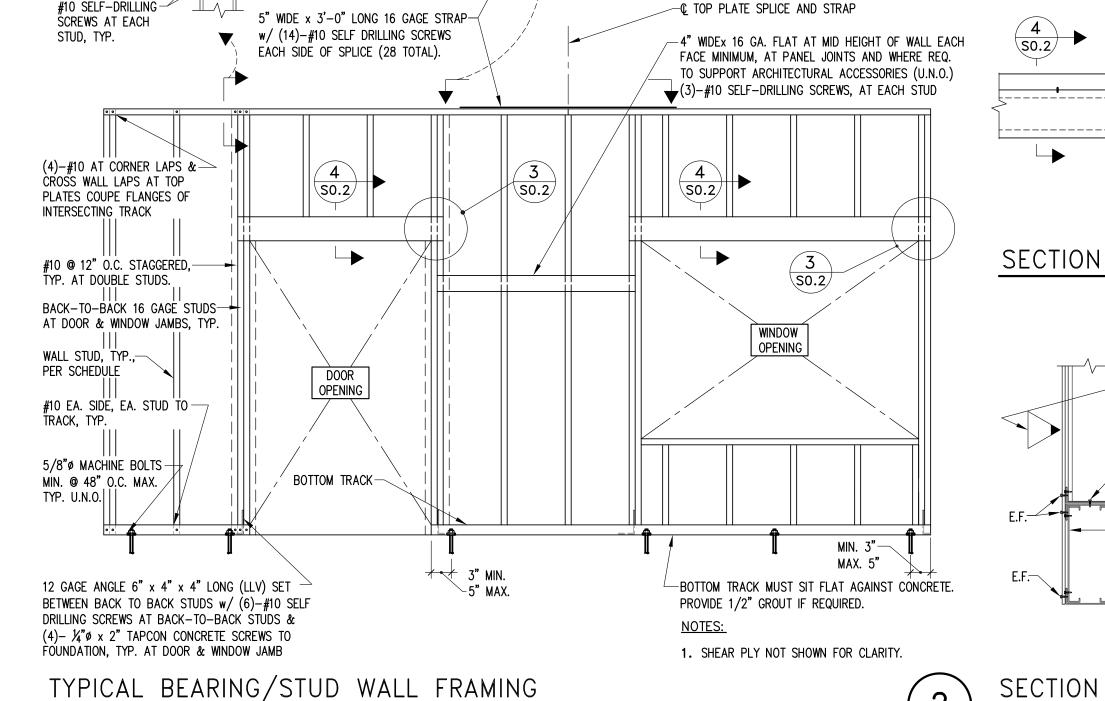

4 so.2 ►

SCALE: 1/2" = 1'-0"

SCALE: 1" = 1'-0"

w/ #10 SELF-DRILLING SCREWS AT 12" O.C.

-(8)-#10 SELF-DRILLING SCREWS


-COPE FLANGE OF BOXED HEADER, TYP.

-16 GAGE TRACK, TYP. AT DOOR & WINDOW JAMB

w/ #10 SELF-DRILLING SCREWS @ 24" O.C. EACH

TO STUD EACH SIDE

SIDE TO DOUBLE STUD

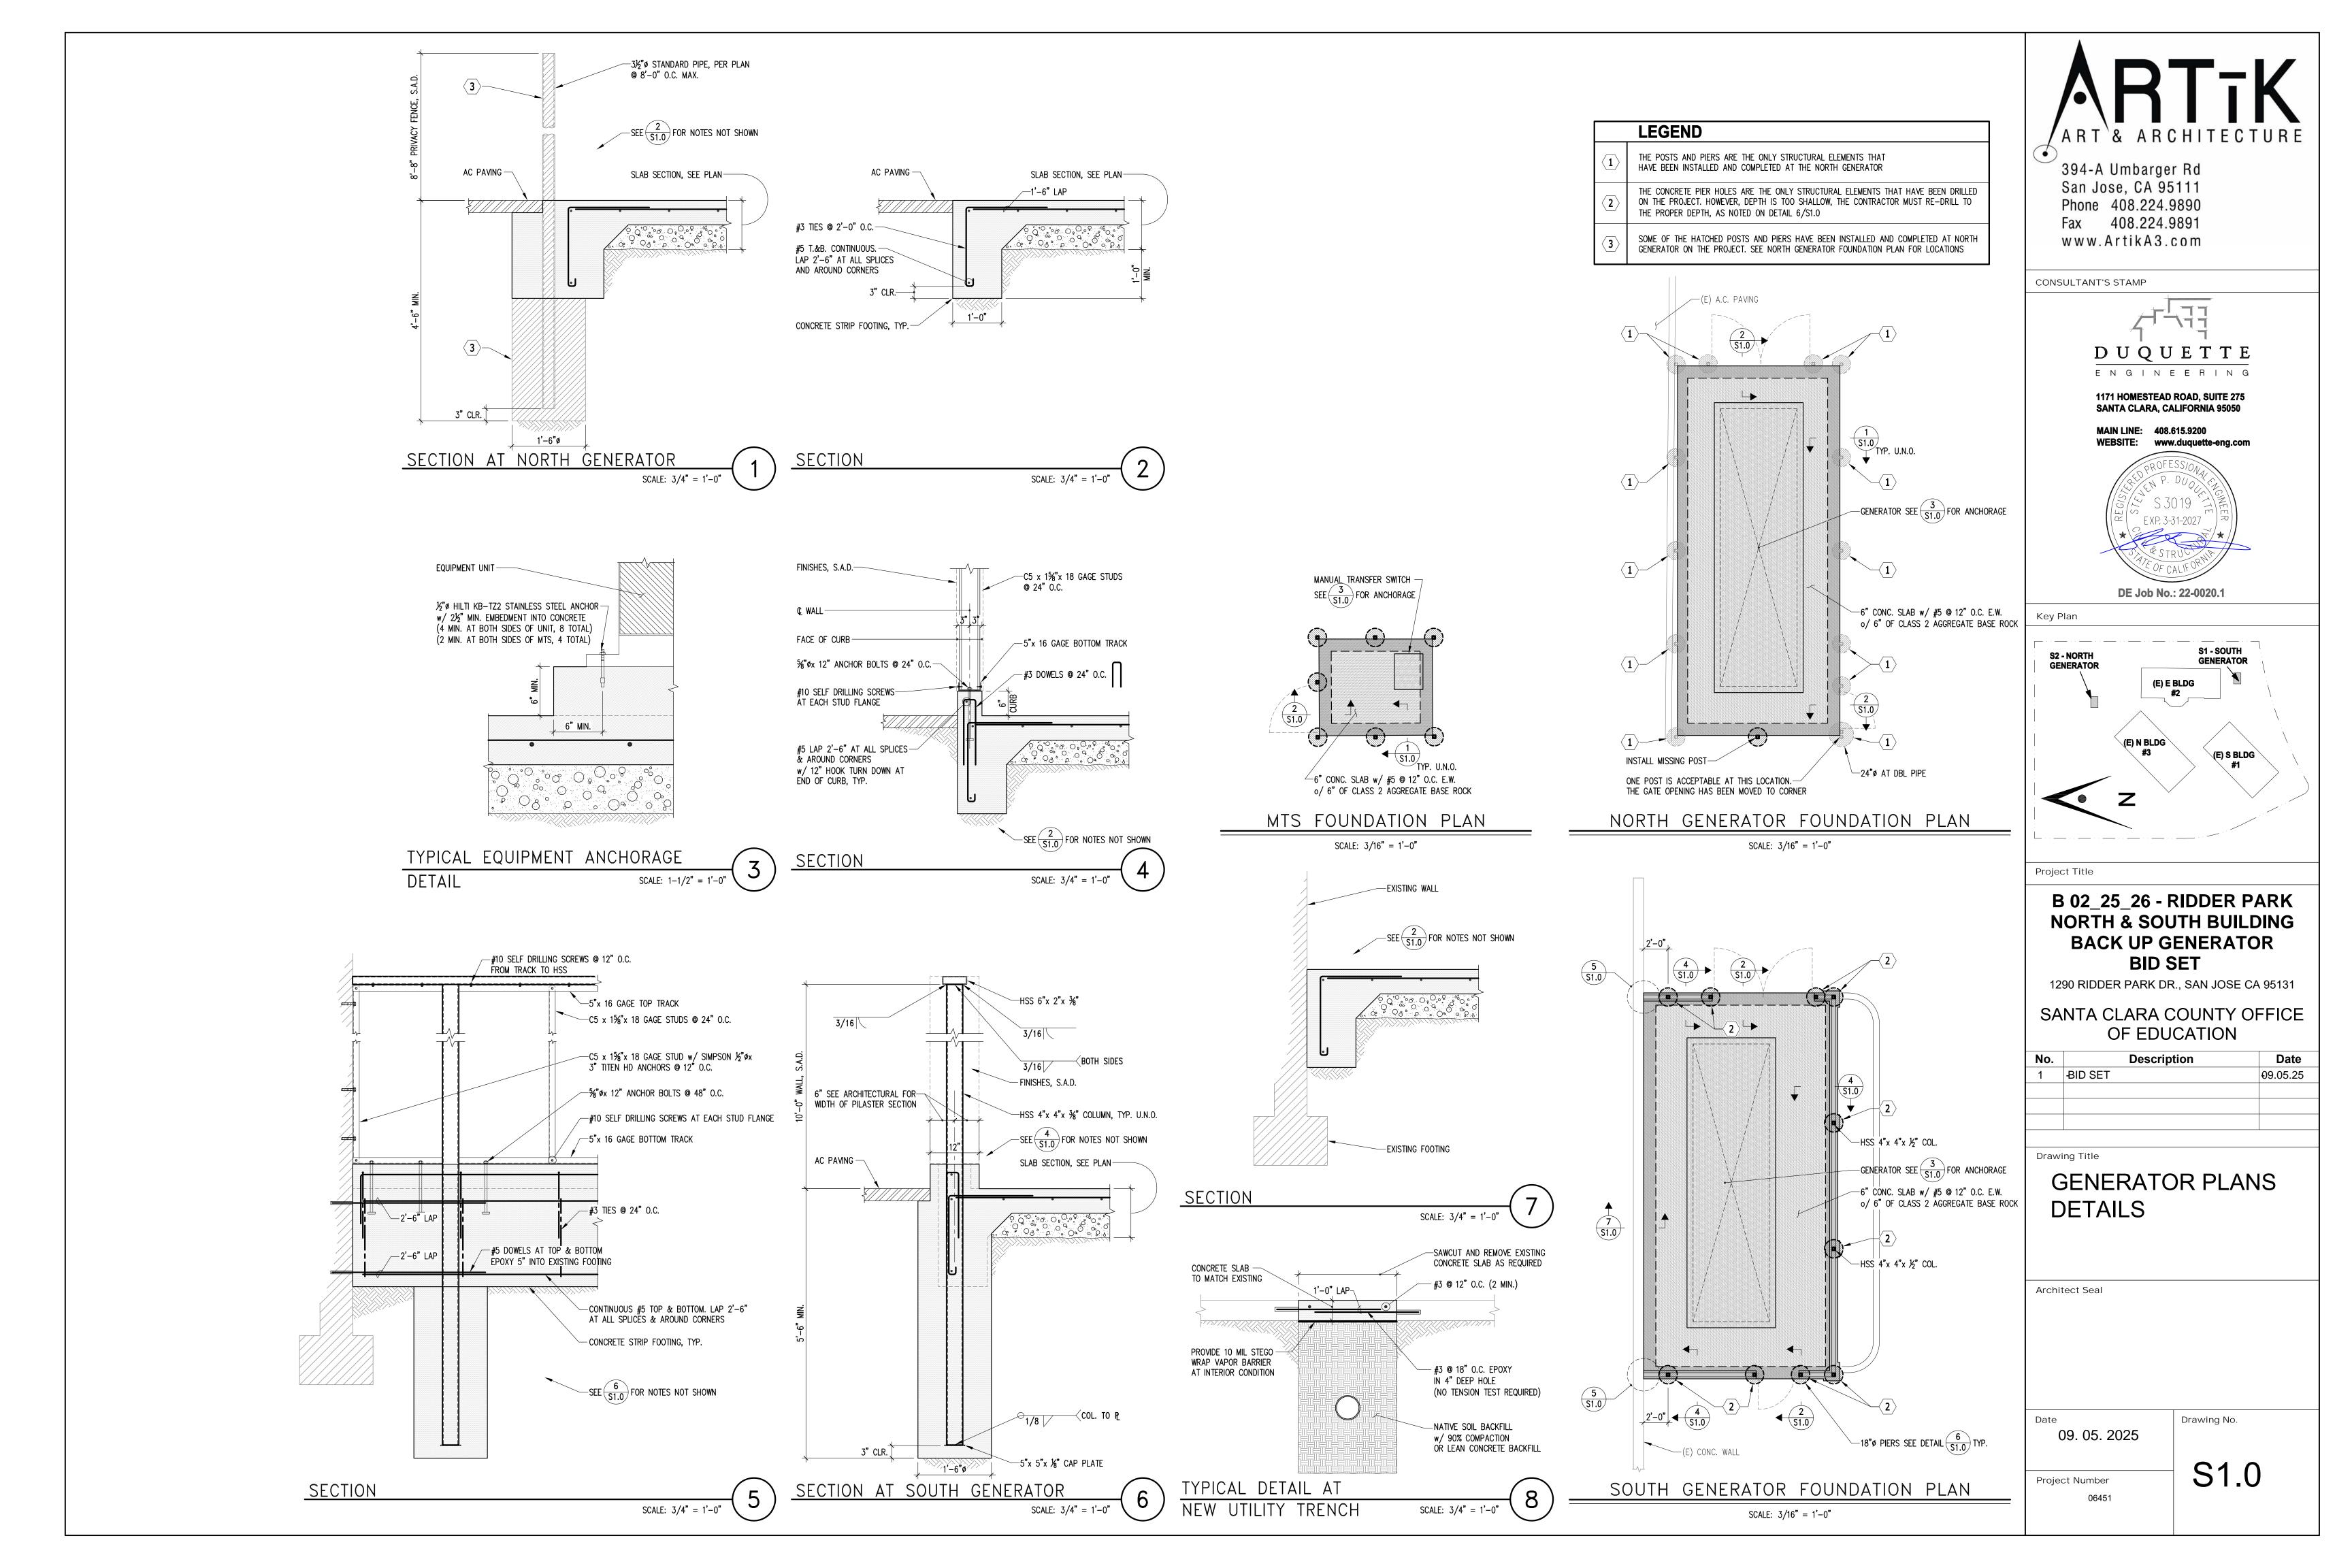


LEAN CONCRETE FILL

LEAN CONCRETE FILL, WHICH IS ALSO REFERRED TO AS CONTROLLED DENSITY FILL (CDF) OR AS "SLURRY CEMENT BACKFILL" IN SECTION 19 OF THE CALTRANS STANDARD SPECIFICATIONS (CALTRANS, 2010), SHOULD CONSIST OF A FLUID, WORKABLE MIXTURE OF AGGREGATE, PORTLAND CEMENT AND WATER.

THE CALTRANS SPECIFICATION FOR THE GRADATION OF CLSM AGGREGATE IS:

SIEVE SIZE	PERCENTAGE PASSING SIE
1½ INCH	100
1 INCH	80-100
¾ INCH	60-100
¾ INCH	50-100
NO.4	40-80
NO.100	10-40


THE AGGREGATE, CEMENT, AND WATER SHALL BE PROPORTIONED EITHER BY WEIGHT OR BY VOLUME. THE WATER CONTENT SHALL BE SUFFICIENT TO PRODUCE A FLUID, WORKABLE MIX THAT WILL FLOW AND CAN BE PUMPED WITHOUT SEGREGATION OF THE AGGREGATE WHILE BEING PLACED. THE LEAN CONCRETE MIX SHOULD BE DESIGNED SUCH THAT THE 28-DAY COMPRESSIVE STRENGTH OF 200 PSI.

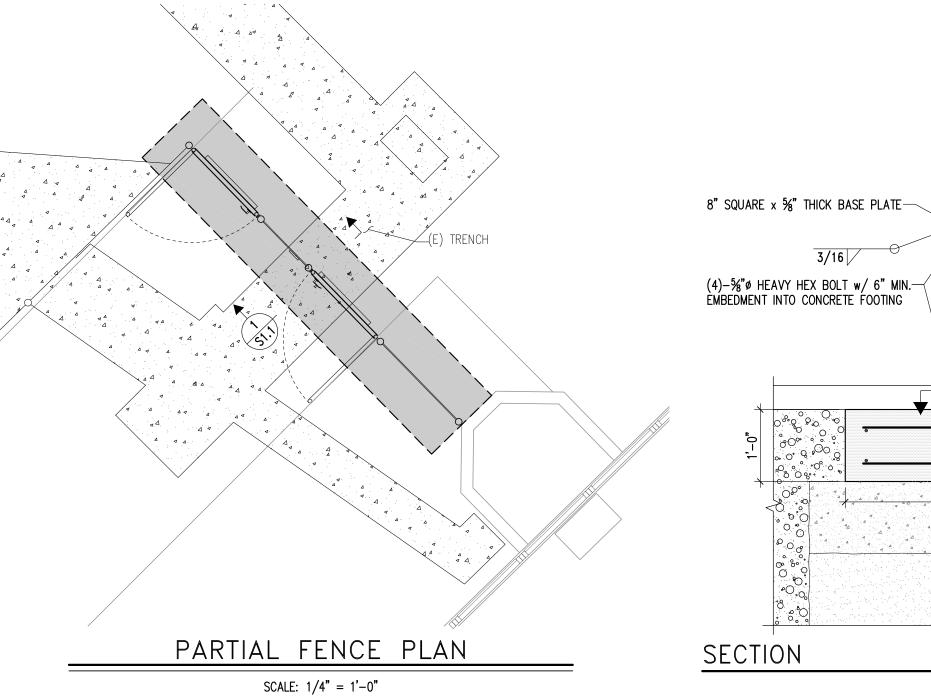




San Jose, CA 95111 Phone 408.224.9890 Fax 408.224.9891 www.ArtikA3.com

CONSULTANT'S STAMP

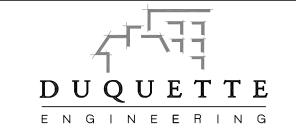

1171 HOMESTEAD ROAD, SUITE 275 SANTA CLARA, CALIFORNIA 95050



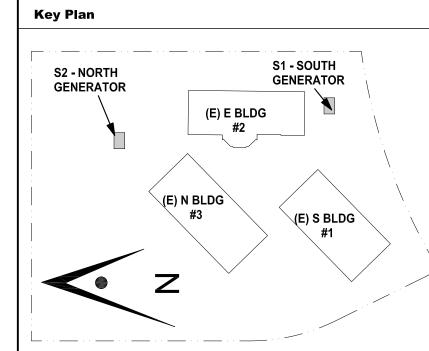

Project Title

B 02_25_26 - RIDDER PARK NORTH & SOUTH BUILDING **BACK UP GENERATOR BID SET**

1290 RIDDER PARK DR., SAN JOSE CA 95131 SANTA CLARA COUNTY OFFICE

OF EDUCATION			
No. Description		Date	
1	-BID SET	09.05.25	

Drawing Title PARTIAL FENCE PLAN

DETAILS

Architect Seal

−3½"ø STANDARD PIPE COLUMN

—4" CONCRETE SLAB

SCALE: 1" = 1'-0'

___#5 REBAR @ 12" O.C. TOP & BOTTOM

(4)-#5 REBAR AT TOP & BOTTOM

Drawing No. 09. 05. 2025

S1.1 Project Number

GRADING AND DRAINAGE PLANS FOR

STANDARD GRADING AND DRAINAGE PLAN NOTES

NOTE: THIS DRAWING IS APPROVED SUBJECT TO:

- 1. ALL GRADING IS SUBJECT TO OBSERVATION BY THE CITY. THE PERMITTEE OR REPRESENTATIVE SHALL NOTIFY THE CITY OF SAN JOSE DEPARTMENT OF PUBLIC WORKS PROJECT INSPECTOR AT LEAST 48 HOURS BEFORE START OF ANY GRADING. THE PROJECT INSPECTOR IS ___ VOICEMAIL (408) ____
- 2. APPROVAL OF THIS PLAN APPLIES ONLY TO:
- (A) THE EXCAVATION, PLACEMENT, AND COMPACTION OF NATURAL EARTH MATERIALS. (B) THE INSTALLATION OF ON-SITE (I.E. PRIVATE PROPERTY) STORM WATER CONVEYANCE AND TREATMENT FACILITIES THAT ARE OUTSIDE OF THE
- 5-FOOT BUILDING ENVELOPE, AND (C) THE INSTALLATION OF RETAINING STRUCTURES THAT ARE INDEPENDENT OF ANY BUILDING STRUCTURE (SEE NOTE 3 BELOW). THIS APPROVAL DOES NOT CONFER ANY RIGHTS OF ENTRY TO EITHER PUBLIC PROPERTY OR THE PRIVATE PROPERTY OF OTHERS. APPROVAL OF THIS PLAN ALSO DOES NOT CONSTITUTE APPROVAL OF ANY IMPROVEMENTS WITH THE EXCEPTION OF THOSE LISTED ABOVE. PROPOSED IMPROVEMENTS. WITH THE EXCEPTION OF THOSE LISTED ABOVE, ARE SUBJECT TO REVIEW AND APPROVAL BY THE RESPONSIBLE AUTHORITIES AND ALL OTHER REQUIRED PERMITS SHALL BE OBTAINED.
- 3. UNLESS OTHERWISE NOTED ON THE PLAN, ANY DEPICTION OF ANY RETAINING STRUCTURE ON THIS PLAN SHALL NOT CONSTITUTE APPROVAL FOR CONSTRUCTION OF THE RETAINING STRUCTURE UNLESS A SEPARATE STRUCTURAL REVIEW BY THE DEPARTMENT OF PUBLIC WORKS IS COMPLETED
- 4. IT SHALL BE THE RESPONSIBILITY OF THE PERMITTEE OR AGENT TO IDENTIFY, LOCATE AND PROTECT ALL UNDERGROUND FACILITIES
- 5. THE PERMITTEE OR AGENT SHALL MAINTAIN THE STREETS, SIDEWALKS, AND ALL OTHER PUBLIC RIGHTS-OF-WAY IN A CLEAN, SAFE, AND USABLE CONDITION. ALL SPILLS OF SOIL, ROCK, OR CONSTRUCTION DEBRIS SHALL BE REMOVED FROM THE PUBLICLY OWNED PROPERTY DURING CONSTRUCTION AND UPON COMPLETION OF THE PROJECT. ALL ADJACENT PROPERTY, PRIVATE OR PUBLIC, SHALL BE MAINTAINED IN A CLEAN. SAFE.
- 6. ALL GRADING SHALL BE PERFORMED IN SUCH A MANNER AS TO COMPLY WITH THE STANDARDS ESTABLISHED BY THE AIR QUALITY MANAGEMENT DISTRICT FOR AIRBORNE PARTICULATES.
- 7. THIS PROJECT HAS BEEN DESIGNED TO COMPLY WITH THE FLOOD HAZARD AREA REGULATIONS AS STATED IN CHAPTER 17.08 OF THE SAN JOSE MUNICIPAL CODE.
- 8. ALL KNOWN WELL LOCATIONS ON THE SITE HAVE BEEN INCLUDED. SUCH WELLS SHALL BE MAINTAINED OR ABANDONED ACCORDING TO CURRENT REGULATIONS ADMINISTERED BY THE SANTA CLARA VALLEY WATER DISTRICT. CALL (408) 265-2600 EXTENSION 2660 TO ARRANGE FOR DISTRICT OBSERVATION OF ALL WELL ABANDONMENTS.
- 9. IN THE EVENT THAT HUMAN REMAINS AND/OR CULTURAL MATERIALS ARE FOUND, ALL PROJECT RELATED CONSTRUCTION SHOULD CEASE WITHIN A 100-FOOT RADIUS. THE CONTRACTOR SHALL, PURSUANT TO SECTION 7050.5 OF THE HEALTH AND SAFETY CODE AND SECTION 5097.94 OF THE PUBLIC RESOURCES CODE OF THE STATE OF CALIFORNIA, NOTIFY THE SANTA CLARA COUNTY CORONER IMMEDIATELY.
- 10. THIS PLAN DOES NOT APPROVE THE REMOVAL OF TREES. APPROPRIATE TREE REMOVAL PERMITS AND METHODS OF TREE PRESERVATION SHOULD BE OBTAINED FROM THE CITY'S PLANNING DEPARTMENT AND THE CITY ARBORIST.
- 11. FOR NON-RESIDENTIAL PROJECTS. AN NON-HAZARDOUS EXPORT RESULTING FROM PROJECT RELATED EXCAVATION OR LAND CLEARING SHALL BE 100% REUSED AND RECYCLED PER CALIFORNIA GREEN BUILDING STANDARDS CODE SECTION 5.408.
- 12. BOLT-DOWN STORM DRAIN MANHOLE COVERS SHALL BE USED WHEN STORM DRAIN MANHOLES ARE NOT IN THE STREET (I.E. WHEN LOCATED IN LANDSCAPED AREAS, SIDEWALKS, ON-SITE EASEMENTS, ETC.).
- 13. STORM DRAIN INLETS:
- A. STENCILING LOCATION: CONTRACTOR SHALL STENCIL ALL STORM DRAIN INLETS AND CATCH BASINS WITH THE "NO DUMPING FLOWS TO NEIGHBORHOOD CREEK" STENCIL. THE "NO DUMPING" MESSAGE SHOULD BE APPLIED TO BOTH THE TOP OF THE CURB AND THE FACE OF THE CURB NEXT TO THE STORM DRAIN INLET, PREFERABLY ON THE LEFT SIDE. IF THIS IS NOT FEASIBLE, PLACE THE MESSAGE IN THE STREET IN FRONT OF THE INLET.
- B. PREVIOUSLY MARKED INLETS: INLETS THAT HAVE ALREADY BEEN LABELED WITH PERMANENT PLASTIC "NO DUMPING" MARKERS DO NOT NEED STENCILING. IF THE INLET HAS BEEN PREVIOUSLY STENCILED, PAINT OVER THE OLD PAINT AND APPLY A FRESH STENCIL.
- C. COLORS AND MATERIALS: USE WHITE TRAFFIC STRIPING PAINT FOR THE BACKGROUND AND BLUE TRAFFIC STRIPING PAINT FOR THE LETTERING. TRAFFIC STRIPING PAINT CAN BE PURCHASED AT COMMERCIAL PAINT RETAILERS OR THROUGH SPECIALTY TRAFFIC CONTROL OR CONSTRUCTION SUPPLIERS. THE USE OF ORDINARY PAINT FOR STORM DRAIN MARKING IS NOT ALLOWED. THE STENCILS MAY BE OBTAINED, AT NO CHARGE, THROUGH THE ENVIRONMENTAL SERVICE DEPARTMENT. CONTACT AMBER SCHAT AT 408-945-3000.
- 14. THE CIVIL ENGINEER INFORMATION AND STATEMENTS:
- A. THE CIVIL ENGINEER FOR THIS PROJECT IS: MARK SORENSON UNDERWOOD & ROSENBLUM, INC. 1630 OAKLAND ROAD, SUITE A114 SAN JOSE, CA. 95131. (408) 453-1222
- B. THIS ROUGH GRADING PLAN HAS BEEN PREPARED UNDER THE DIRECTION OF A LICENSED ENGINEER AND DESIGNED BASED ON THE RECOMMENDATIONS OF THE REFERENCE PROJECT GEOTECHNICAL REPORT.
- C. THE STORMWATER CONVEYANCE SYSTEM HAS BEEN DESIGNED IN ACCORDANCE WITH THE APPROPRIATE BUILDING AND PLUMBING CODES OR HAS BEEN PROVEN TO BE DESIGNED WITH ADEQUATE CAPACITY THROUGH SIGNED AND SEALED HYDRAULIC CALCULATIONS.
- 15. SOILS ENGINEER INFORMATION AND REQUIREMENTS:
- C. ALL GRADING WORK SHALL CONFORM TO THE RECOMMENDATION OF THE PROJECT GEOTECHNICAL REPORT AND/OR THE PROJECT SOIL ENGINEER.
- D. ALL GRADING WORK SHALL BE OBSERVED AND APPROVED BY THE SOIL ENGINEER. THE SOIL ENGINEER SHALL BE NOTIFIED AT LEAST 48 HOURS BEFORE BEGINNING ANY GRADING. UNOBSERVED AND/OR UNAPPROVED GRADING WORK SHALL BE REMOVED AND REPLACED UNDER
- 16. A POST CONSTRUCTION "FINAL" REPORT IS REQUIRED BY THE DIRECTOR OF PUBLIC WORKS FROM A CIVIL ENGINEER RETAINED BY THE OWNER TO OBSERVE THE CONSTRUCTION STATING:
- A. "THAT THE CONSTRUCTION CONFORMS TO THE LINES AND GRADES ON THE APPROVED PLANS;" OR
- B. "THAT ALL SIGNIFICANT CHANGES WERE REVIEWED AND APPROVED IN ADVANCE BY THE DEPARTMENT OF PUBLIC WORKS" AND THE CIVIL ENGINEER SHALL SUBMIT A "RECORD DRAWING" PLAN.
- 17. A POST CONSTRUCTION "FINAL" REPORT IS REQUIRED BY THE DIRECTOR OF PUBLIC WORKS FROM A SOIL ENGINEER AND ALSO FROM AN ENGINEERING GEOLOGIST IF THE PROJECT IS IN A GEOLOGIC HAZARD ZONE, STATING:
- A. "THAT THE ANTICIPATED CONDITIONS AND MATERIALS AND ACTUAL SITE CONDITIONS AND MATERIALS WERE COMPATIBLE," AND SUPPLY SUPPORTING DATA: OR
- B. "THAT THE DESIGN WAS MODIFIED TO MEET THE NEW CONDITIONS AND WAS REVIEWED AND APPROVED IN ADVANCE BY THE DEPARTMENT OF PUBLIC WORKS;" AND PROVIDE SUPPORTING DATA FOR THESE STATEMENTS.
- 18. ACCORDING TO THE CITY'S WASTE WATER ORDINANCE, THE USE OF POTABLE (PIPED OR HYDRANT) WATER FOR BUILDING OR CONSTRUCTION PURPOSES INCLUDING CONSOLIDATION OF BACKFILL OR DUST CONTROL IS PROHIBITED.
- RECLAIMED WATER IS AVAILABLE AT MULTIPLE LOCATIONS ACROSS THE CITY. TO CERTIFY FOR A RECYCLED WATER METER, PLEASE CALL LYLE FROHMAN AT (408) 794-6805.
- AN APPLICATION FOR AN EXCEPTION PERMIT TO APPROVE USE OF HYDRANT WATER CAN BE CONSIDERED IN THE PW DEVELOPMENT SERVICES OFFICE. FAX-BACK SERVICE IS PROVIDED FOR THIS PERMIT APPLICATION -- CONTACT (408) 535-7802.
- 19. A HAUL ROUTE PERMIT IS REQUIRED FOR ALL PROJECTS MOVING MORE THAN 10,000 C.Y. OF EARTH. THIS GRADING PERMIT IS INVALID WITHOUT THE HAUL ROUTE PERMIT. HAUL ROUTE PERMITS SHALL BE OBTAINED FROM THE CITY'S TRANSPORTATION DEPARTMENT.
- 20. GRADING WILL NOT BE ALLOWED BETWEEN OCTOBER 1ST AND APRIL 30TH OF ANY YEAR WITHOUT EROSION CONTROL PLANS AND MEASURES APPROVED BY THE DIRECTOR OF PUBLIC WORKS. STORMWATER POLLUTION PREVENTION MEASURES IN ACCORDANCE WITH CITY SPECIFICATIONS AND WITH THE DOCUMENT "CLEAN BAY BLUEPRINT" SHALL BE IMPLEMENTED THROUGHOUT THE YEAR TO THE SATISFACTION OF THE DIRECTOR OF PUBLIC
- 21. A POST CONSTRUCTION "AS-BUILT" PLAN IS REQUIRED BY THE DIRECTOR OF PUBLIC WORKS FROM A CIVIL OR SOILS ENGINEER RETAINED BY THE OWNER TO PROVIDE THE FINAL HORIZONTAL AND VERTICAL LOCATIONS OF THE IMPROVEMENT APPROVED WITH THIS PLAN. SUCH IMPROVEMENTS INCLUDE SUBDRAINS, ON-SITE STORM WATER CONVEYANCE AND TREATMENT SYSTEMS, AND ON-SITE RETAINING STRUCTURES.

SSCOE BACKUP GENERATOR SANTA CLARA COUNTY OFFICE OF EDUCATION 1290 RIDDER PARK DR SAN JOSE, CALIFORNIA

INDEX

ENLARGED PLAN-N BUILDING EXISTING CONDITION

ENLARGED PLAN-S BUILDING EXISTING CONDITION

N BUILDING GRADING AND UTILITY PLAN

S BUIDING GRADING AND UTILITY PLAN

DATE

EXPIRATION DATE

OVERALL SITE PLAN

APPROVED FOR GRADING

AND DRAINAGE ONLY

DEPARTMENT OF PUBLIC WORKS

CITY OF SAN JOSE, CALIFORNIA

SHEET

DETAILS

PROJECT ENGINEER

22- -GR


PERMIT NUMBER

COVERSHEET



394-A Umbarger Rd San Jose, CA 95111 Phone 408.224.9890 408.224.9891 www.ArtikA3.com



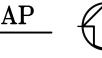

I FGEND

LEGEND		
DESCRIPTION	TO BE CONST.	EXISTING
DISTINCTIVE BOUNDARY LINE		
CURB		
CURB AND GUTTER		
CONCRETE SIDEWALKS/WALKWAYS	4	
GENERATOR CONRETE PAD 6" CONC. SLAB W/ #5 @ 12" O.C. E.W O/ 6" OF CLASS II AGG. BASE ROCK (SEE STRUCTURAL PLAN)		
NEW AC PAVEMENT - TRAFFIC		

(3" AC ON 9" CLASS 2 AB ON 6" RECOMPACTED SUBGRADE (95%)) AREA DRAIN O AD o RWL DRAIN WATER LEADER GAS LINE RECYCLE WATER LINE ----- RW -----COMMUNICATION LINE —— COM —— ELECTRICAL LINE STORM DRAIN CLEANOUT O SDCO O SSCO SANITARY SEWER CLEANOUT SAWCUT LINE **FENCE**

EARTH WORK QUANTITIES				
CUT:	0	CY		
FILL:	0	CY		
EXPORT: _	0	CY		
			S SHOWN ARE APPROXIMATE. R'S RESPONSIBILITY TO	

INDEPENDENTLY ESTIMATE QUANTITIES FOR HIS/HER OWN USE.

"THE GENERATOR HAS BEEN REVIEWED AND APPROVED BY CHRIS VIEIRA (ELECTRICIAN) ON 06-16-2023 AND KWON YEW

FILL LOCATION REFER TO APPROVED E7"

YAP (BUILDING) ON 03-15-2023, FOR THE GENERATOR DIESEL


AD AREA DRAIN HP HIGH POINT AC ASPHALT CONCRETE INVERT ELEVATION IN ARCH ARCHITECT JOINT TRENCH BACK OF CURB LOW POINT BW BACK OF WALK PAVEMENT CONCRETE PAD PAD ELEVATION CATCH BASIN POC POINT OF CONNECTION CLF CHAIN LINK FENCE PVC POLYVINYL CHLORIDE DS DOWNSPOUT (REC) PER RECORD DRAWINGS EASE EASEMENT S.A.D SEE ARCHITECTURE DRAWING EX. EXISTING S.E.D SEE ELECTRICAL DRAWING FF FINISH FLOOR S.L.D SEE LANDSCAPE DRAWING S.S.D SEE STRUCTURAL DRAWING FL FLOW LINE GRADE SW SIDEWALK TOP OF CURB GRADE BREAK


TYP.

TYPICAL

WATER METER

ABBREVIATIONS

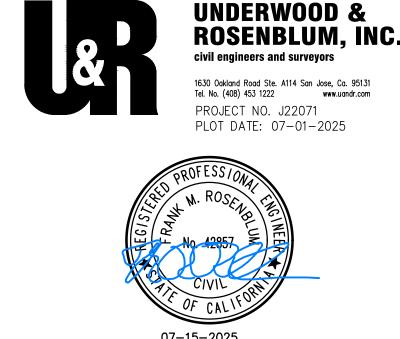

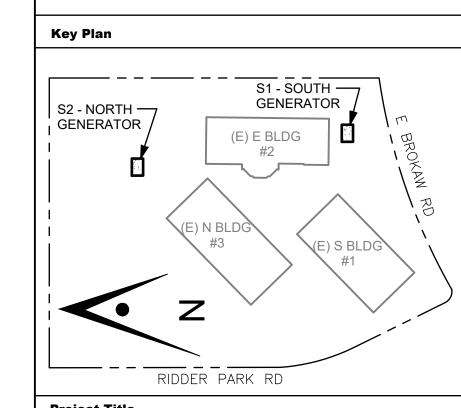

Project Title

B 02 25 26 - RIDDER PARK NORTH & SOUTH BUILDING BACK UP GENERATOR BID SET

1290 RIDDER PARK DR., SAN JOSE CA 95131


BID SET OF EDUCATION


No.	Description	Date			
1	BID SET	09.05.25			
Drawing Title					


Consultant Seal

Drawing No. 09. 05. 2025

Project Number

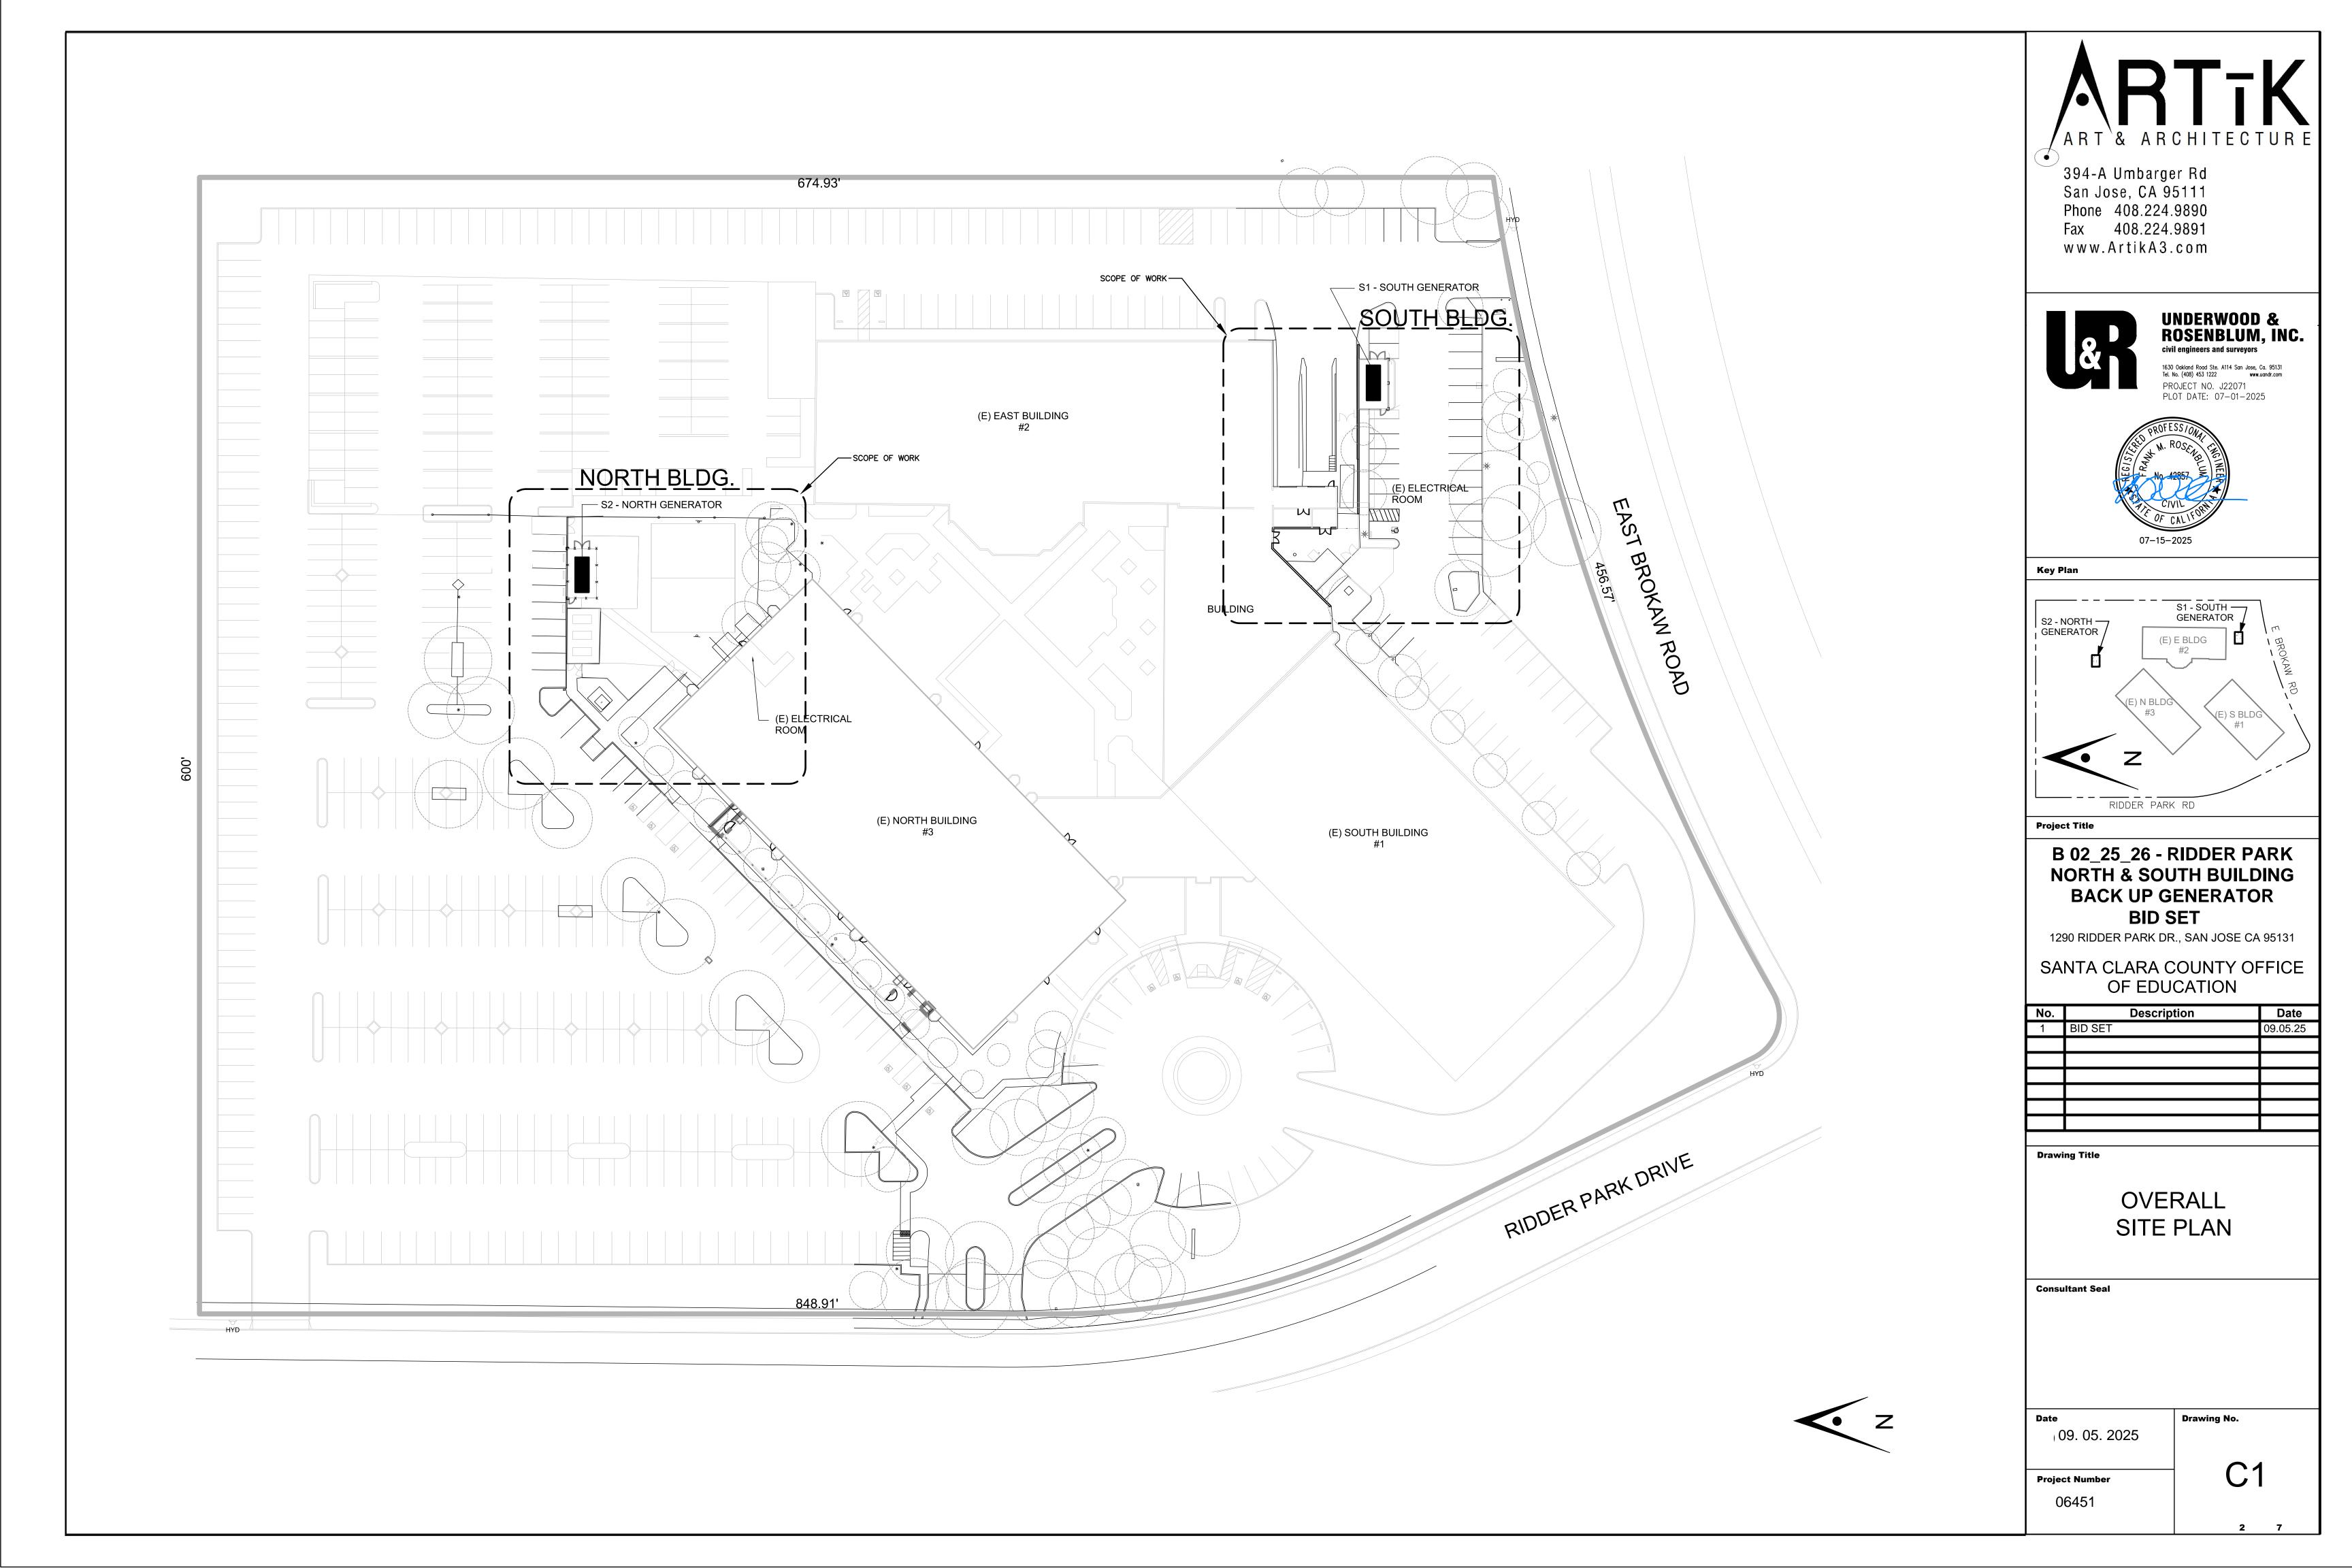

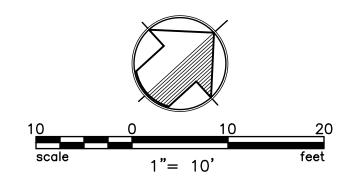

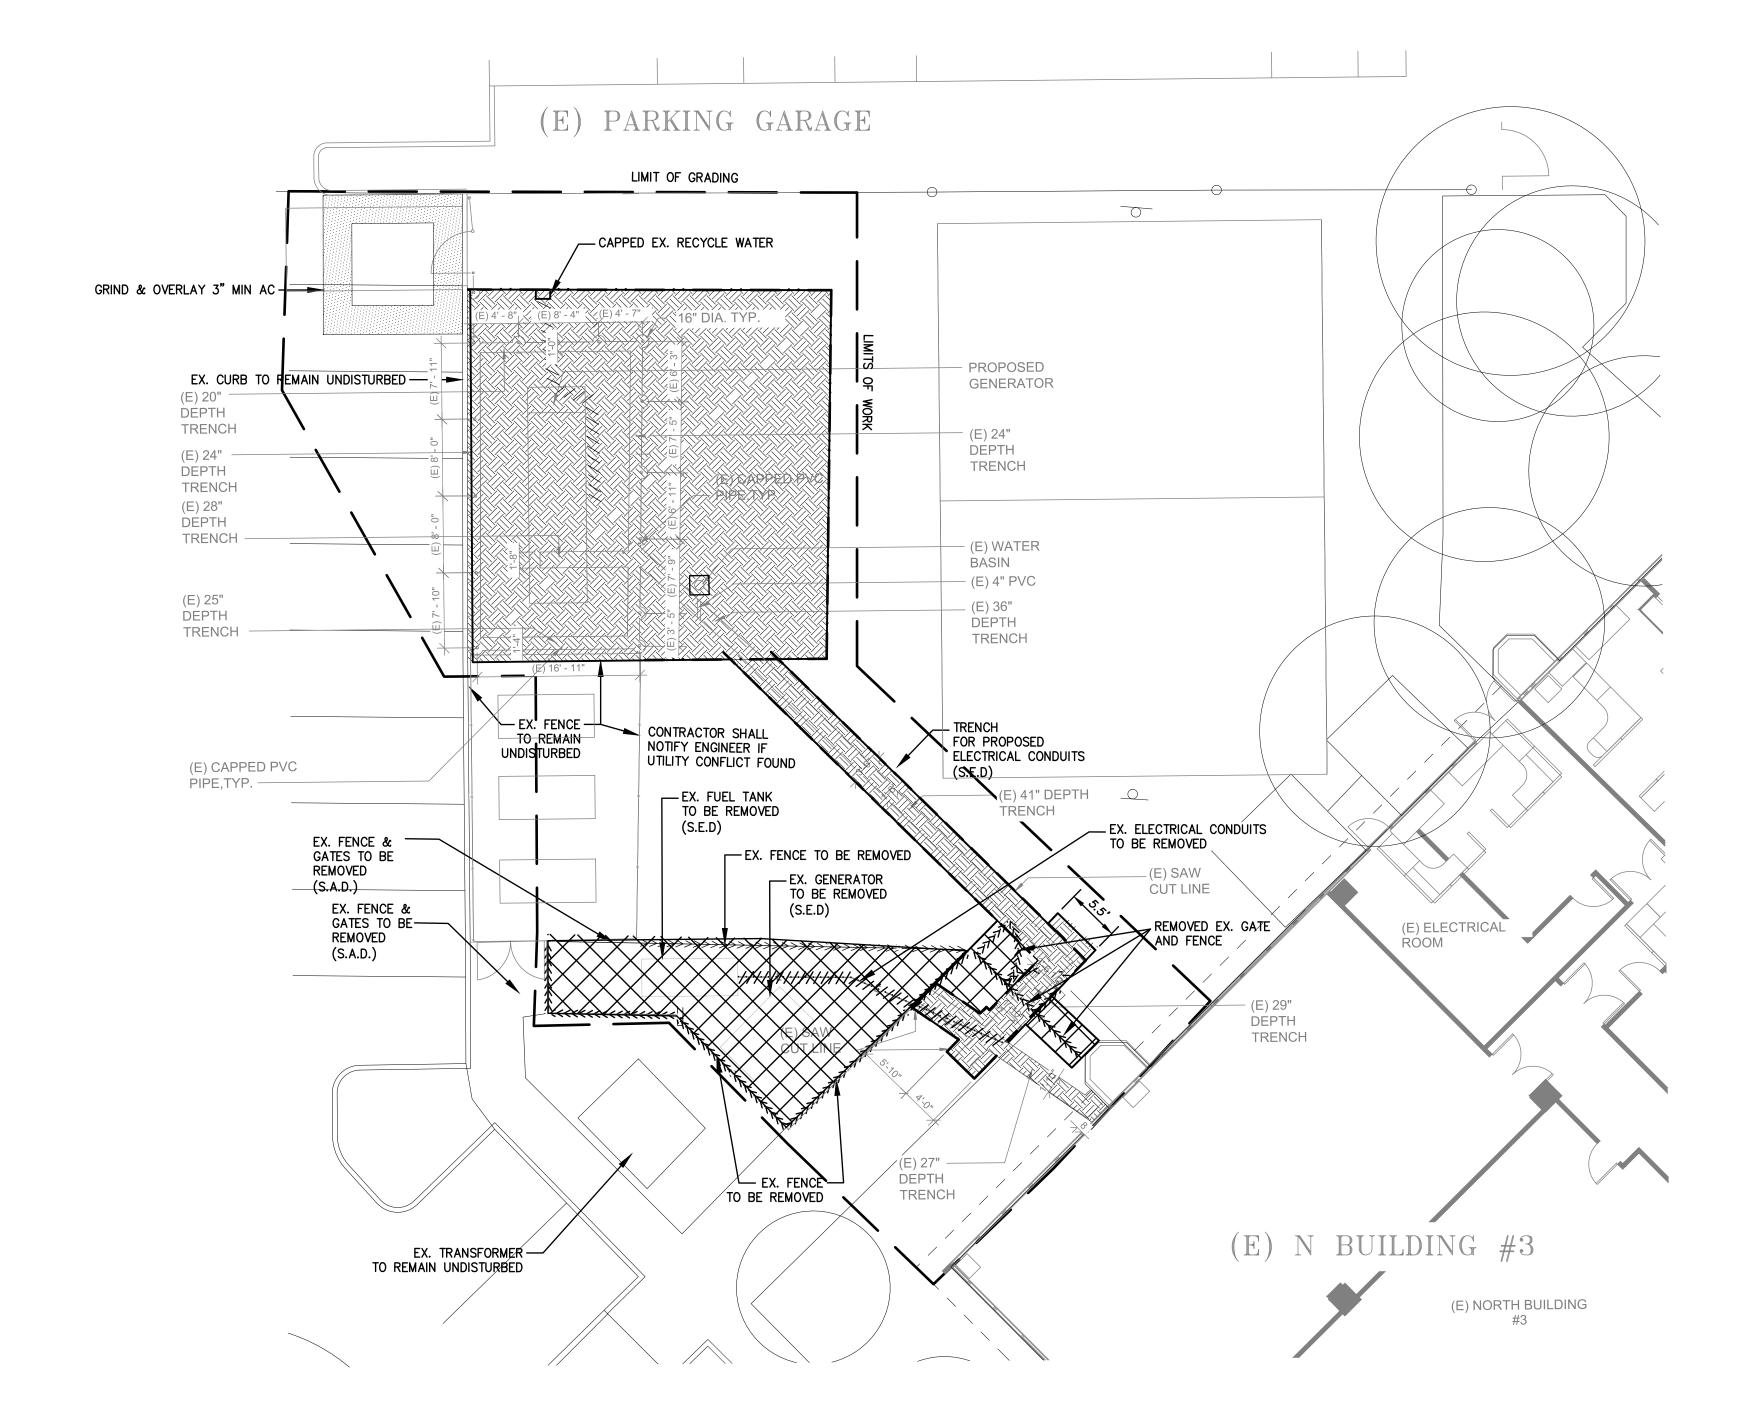



ALL CONTRACTORS SHALL CALL UNDERGROUND SERVICE ALERT (CA. 1-800-642-2444)

48 HOURS BEFORE DIGGING AND OBTAIN AN IDENTIFICATION NUMBER (SECTION 4210.1 OF THE GOVERNMENT CODE).

IT SHALL BE THE RESPONSIBILITY OF CONTRACTORS OR AGENTS TO IDENTIFY, LOCATE AND PROTECT ALL UTILITIES ABOVE AND UNDERGROUND, INCLUDING ANY UTILITIES NOT SHOWN. CONTRACTOR IS TO NOTIFY UTILITIES 48 HOURS PRIOR TO REMOVAL OF ANY GAS, ELECTRICAL, TELEPHONE, SEWER OR WATER LINES.


EXISTING UTILITIES SHOWN WERE IDENTIFIED FROM A SURFACE SURVEY. ADDITIONAL UNDERGROUND UTILITIES DO EXIST AND COULD NOT BE IDENTIFIED ON THIS MAP.

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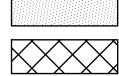
DEMOLITION NOTES: "FOR INFORMATION ONLY"

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- A. MATERIAL THAT THE CONTRACTOR BELIEVES MAY BE MATERIAL THAT IS HAZARDOUS WASTE, AS DEFINED IN SECTION 25117 OF THE HEALTH AND SAFETY CODE, THAT IS REQUIRED TO BE REMOVED TO A CLASS I, CLASS II, OR CLASS III DISPOSAL SITE IN ACCORDANCE WITH PROVISIONS OF EXISTING LAW.
- B. SUBSURFACE OR LATENT PHYSICAL CONDITIONS AT THE SITE DIFFERING FROM THOSE
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- 5. CONTRACTOR SHALL REMOVE ALL U.S.A. MARKINGS AS SOON AS THEY ARE NO LONGER NEEDED. REMOVAL OF PAINT SHALL BE BY HIGH WATER PRESSURE METHOD ONLY.
- 6. CONTRACTOR IS RESPONSIBLE FOR CONTACTING APPROPRIATE UTILITY AGENCY PRIOR TO DEMOLITION OF ANY EXISTING UTILITIES.
- 7. REMOVE EXISTING PAVEMENT, CURB AND UTILITIES (AS SHOWN).
- 8. CONTRACTOR TO CONTROL DUST DURING DEMOLITION.
- 9. CONTRACTOR TO RECYCLE MATERIALS WHENEVER POSSIBLE.


DEMOLITION LEGEND

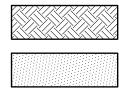

EXISTING AREA



GRIND & 3" AC OVERLAY

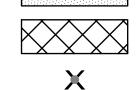

REMOVE EXISTING PAVEMENT

REMOVE EXISTING TREE *** *** REMOVE EXISTING CURB/GUTTER REMOVE EXISTING FENCE AND GATE ////RW//// REMOVE EXISTING UNDERGROUND UTILITY

LIMIT OF SITE DEMOLITION, CLEARING AND GRADING

SAW CUT LINE ASPHALT CONCRETE AREA DRAIN CATCH BASIN CLEAN OUT CONCRETE EX., EXIST. **EXISTING**


SEE ARCHITECTURE DRAWING S.E.D SEE ELECTRICAL DRAWING TYP.

> FOR INFORMATION ONLY NOT REVIEWED OR APPROVED BY PUBLIC WORKS




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Key Plan

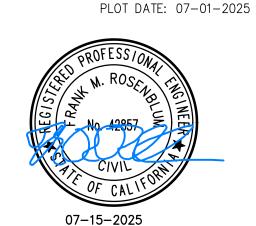

Project Title

B 02_25_26 - RIDDER PARK NORTH & SOUTH BUILDING **BACK UP GENERATOR BID SET**

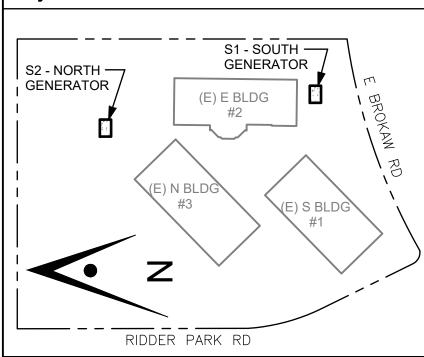1290 RIDDER PARK DR., SAN JOSE CA 95131

SANTA CLARA COUNTY OFFICE OF EDUCATION

No.	Description	Date
1	BID SET	09.05.25


Drawing Title

ENLARGED PLAN N BUILDING **EXISTING CONDITION**

Consultant Seal

Drawing No. 09. 05. 2025

C1.1 **Project Number** 06451

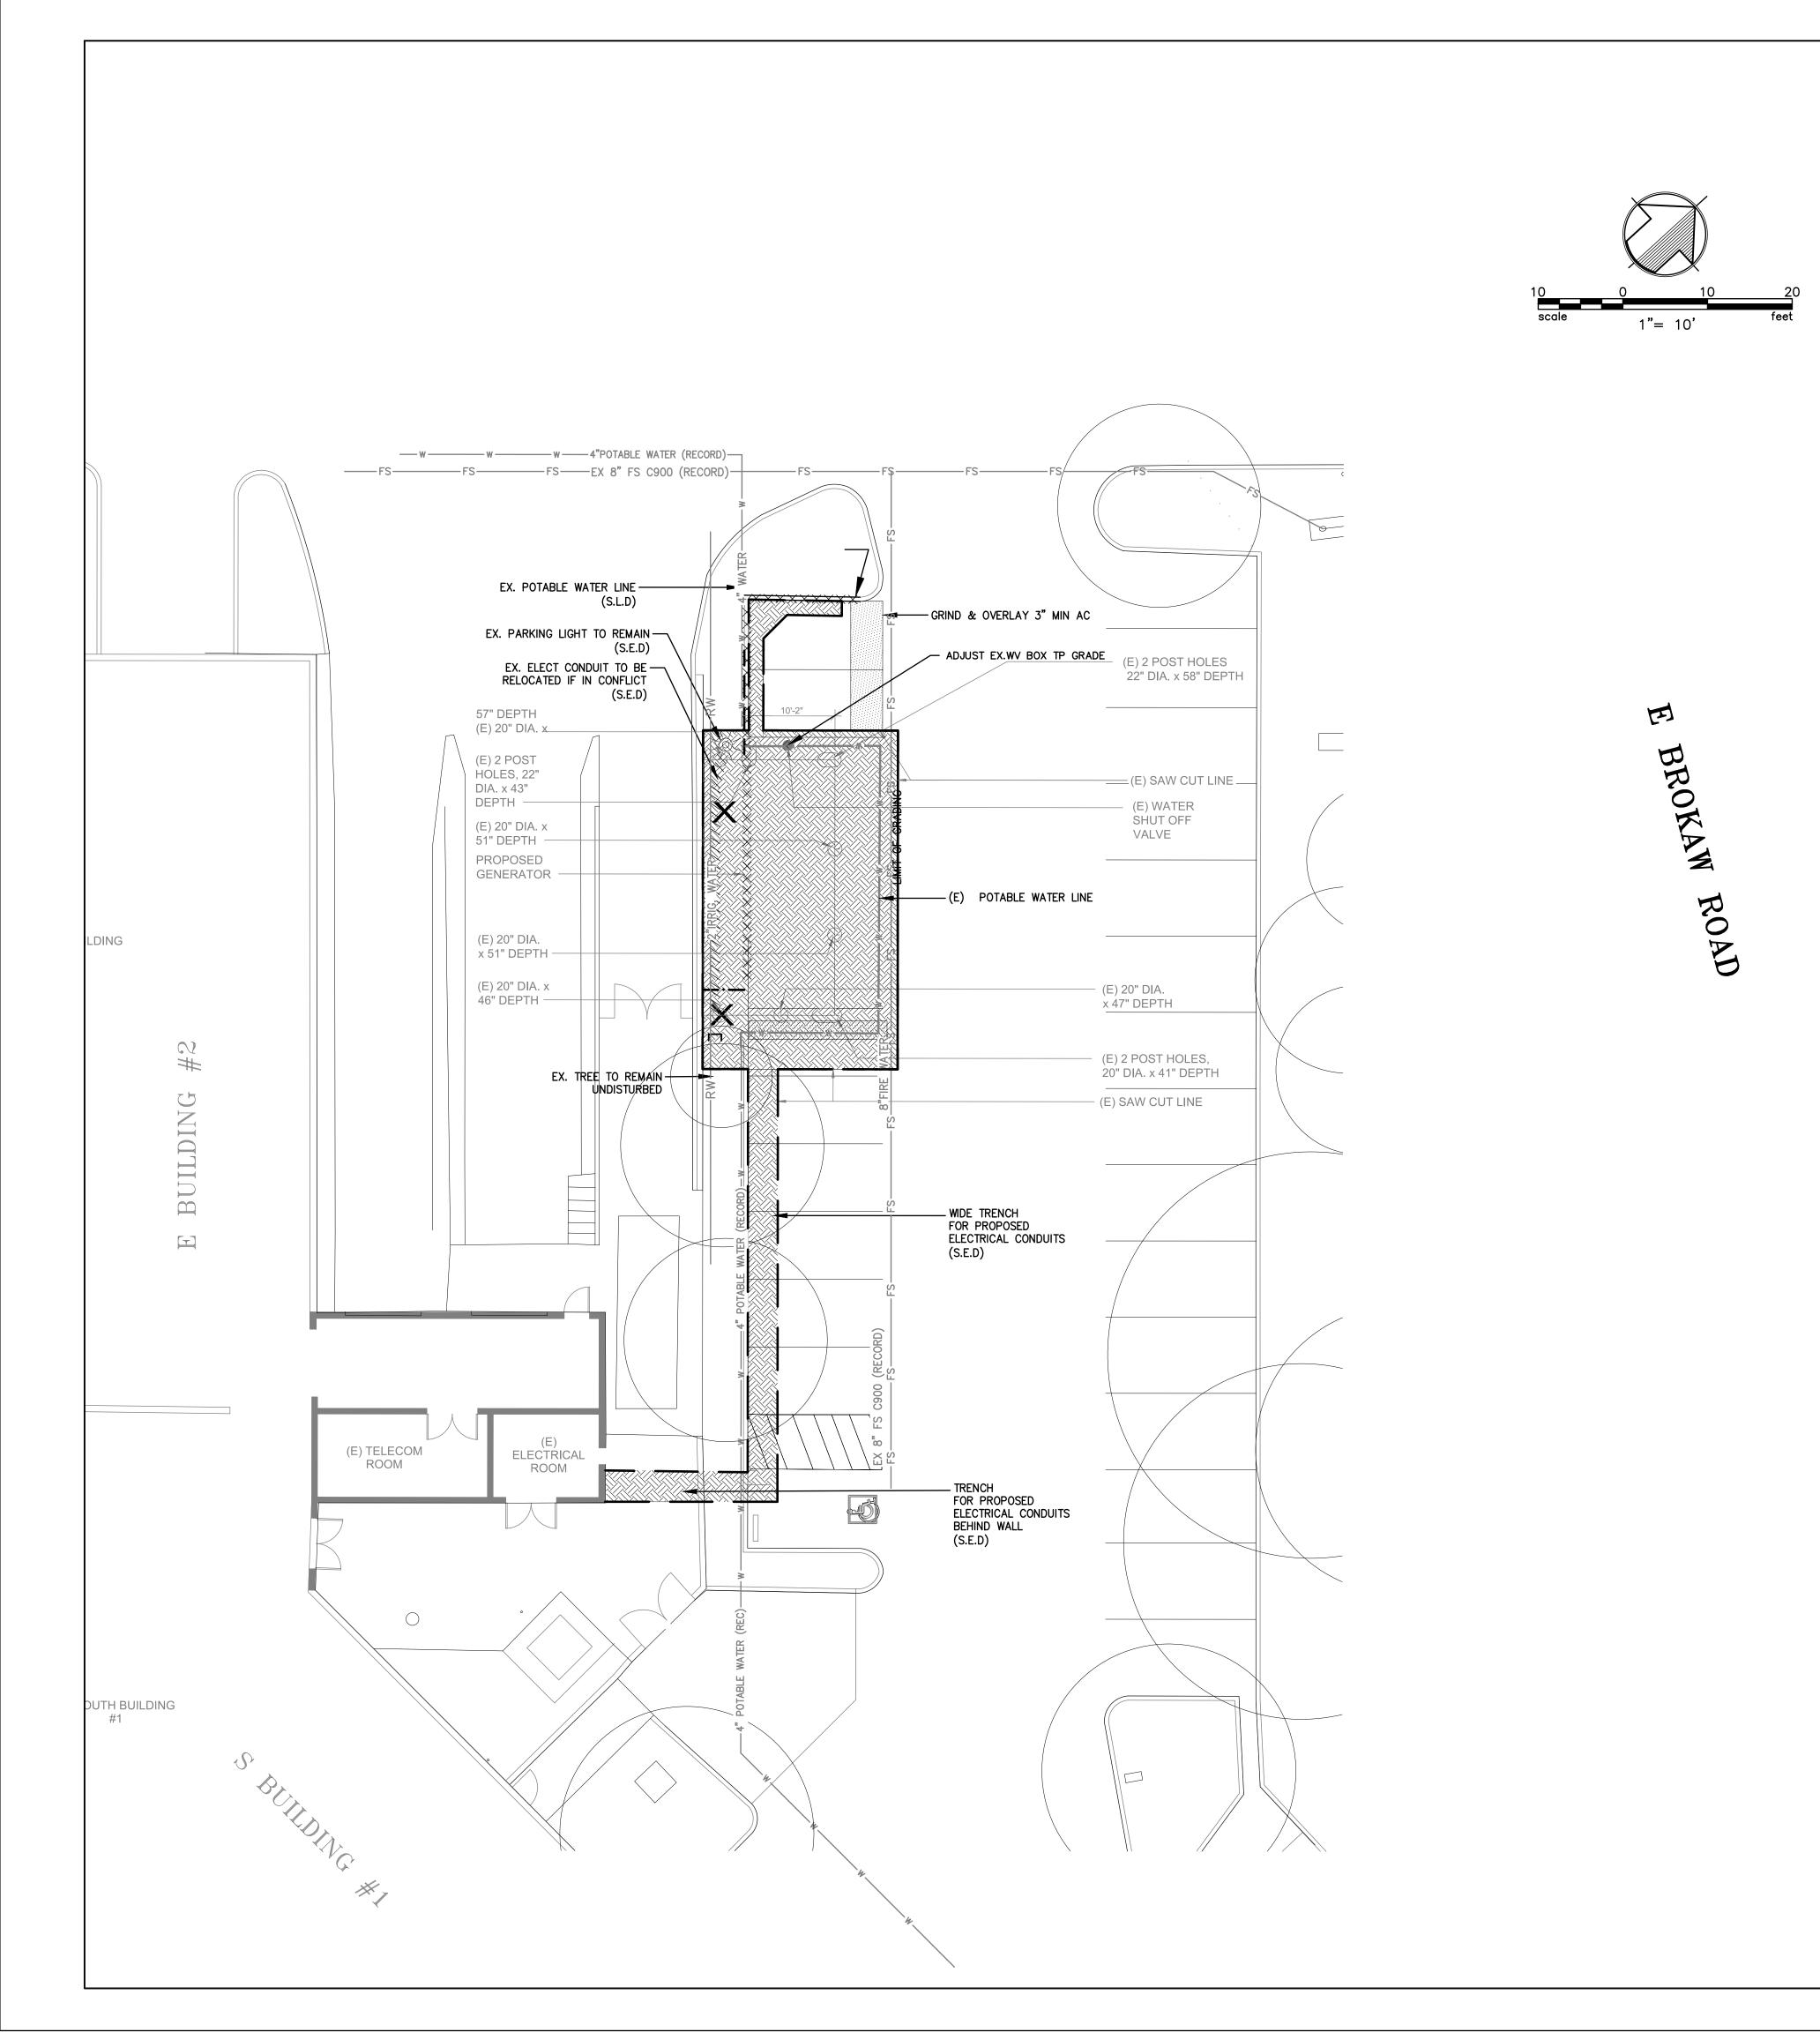



ALL CONTRACTORS SHALL CALL UNDERGROUND SERVICE ALERT (CA. 1-800-642-2444)

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DEMOLITION LEGEND

EXISTING AREA

REMOVE EXISTING PAVEMENT

REMOVE EXISTING TREE

GRIND & 3" AC OVERLAY

*** *** REMOVE EXISTING CURB/GUTTER

REMOVE EXISTING FENCE AND GATE REMOVE EXISTING UNDERGROUND UTILITY

LIMIT OF SITE DEMOLITION, CLEARING AND GRADING

SAW CUT LINE ASPHALT CONCRETE AREA DRAIN CATCH BASIN


CLEAN OUT CONCRETE **EXISTING**

SEE ARCHITECTURE DRAWING S.E.D SEE ELECTRICAL DRAWING

> FOR INFORMATION ONLY NOT REVIEWED OR APPROVED BY PUBLIC WORKS




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PLOT DATE: 07-01-2025

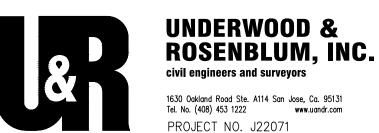

Key Plan



Project Title

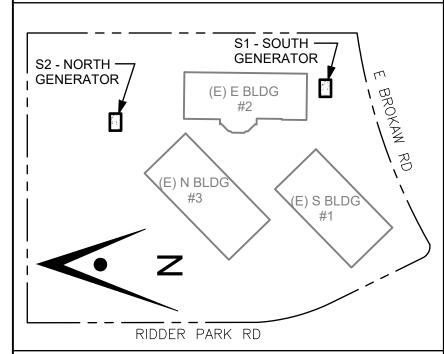B 02_25_26 - RIDDER PARK NORTH & SOUTH BUILDING **BACK UP GENERATOR BID SET**

1290 RIDDER PARK DR., SAN JOSE CA 95131

SANTA CLARA COUNTY OFFICE OF EDUCATION

No.	Description	Date
1	BID SET	09.05.25


Drawing Title

ENLARGED PLAN S BUILDING **EXISTING CONDITION**

Consultant Seal

Drawing No. 09. 05. 2025

C1.2 **Project Number** 06451

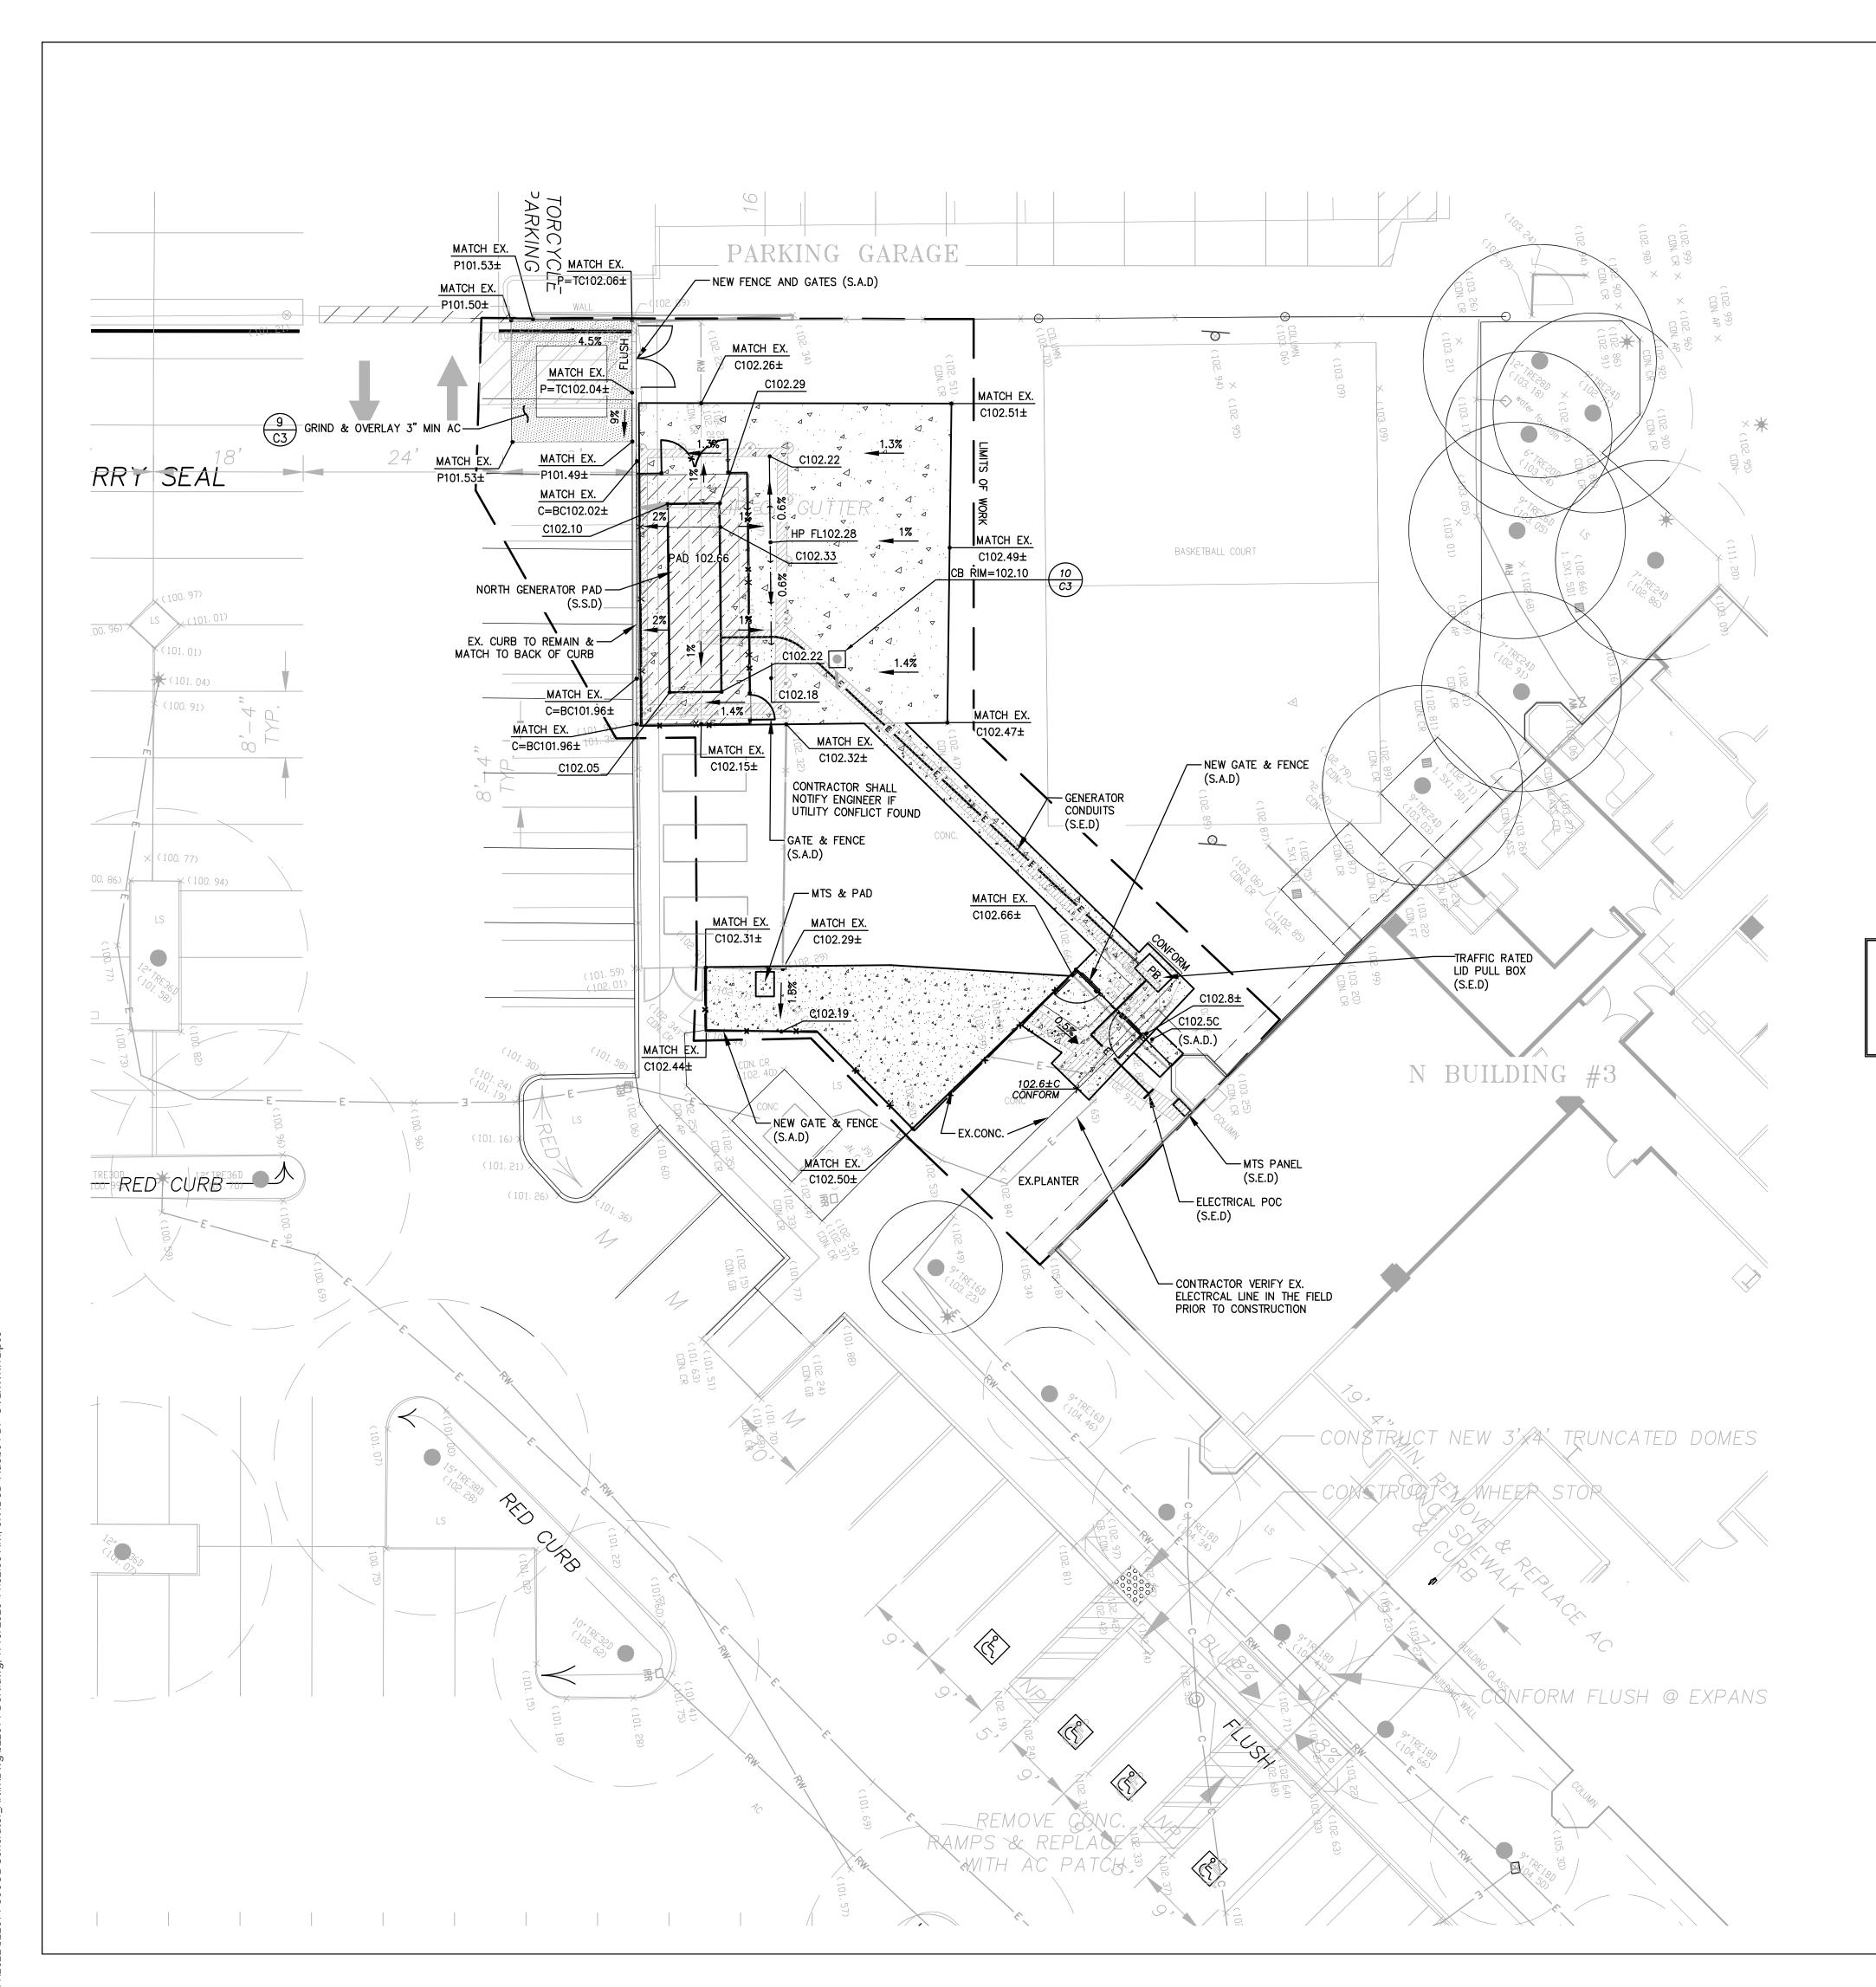



ALL CONTRACTORS SHALL CALL UNDERGROUND SERVICE ALERT (CA. 1-800-642-2444)
48 HOURS BEFORE DIGGING AND OBTAIN AN IDENTIFICATION

48 HOURS BEFORE DIGGING AND OBTAIN AN IDENTIFICATION NUMBER (SECTION 4210.1 OF THE GOVERNMENT CODE).


IT SHALL BE THE RESPONSIBILITY OF CONTRACTORS OR AGENTS TO IDENTIFY, LOCATE AND PROTECT ALL UTILITIES ABOVE AND UNDERGROUND, INCLUDING ANY UTILITIES NOT SHOWN. CONTRACTOR IS TO NOTIFY UTILITIES 48 HOURS PRIOR TO REMOVAL OF ANY GAS, ELECTRICAL, TELEPHONE, SEWER OR WATER LINES.

EXISTING UTILITIES SHOWN WERE IDENTIFIED FROM A SURFACE SURVEY.

ADDITIONAL UNDERGROUND UTILITIES DO EXIST AND COULD NOT BE IDENTIFIED ON THIS MAP.

CONTRACTOR POTHOLE TO VERIFY EXISTING UTILITIES INVERT PRIOR TO CONSTRUCT NEW UTILITIES.

IF THERE IS A CONFLICT, PLEASE NOTIFY TO THE CIVIL ENGINEER IMMEDIATELY.

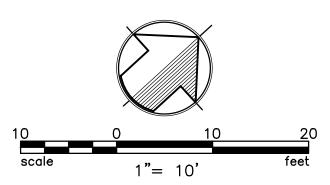

SEE SHEET CO FOR NOTES AND LEGEND


THIS PROJECT WILL NOT CREATE AND/OR REPLACE 5,000 S.F. OF IMPERVIOUS SURFACE AND IS THEREFORE NOT A REGULATED PROJECT AND DOES NOT REQUIRE LOW IMPACT DEVELOPMENT TREATMENT MEASURES.

LEGEND

DESCRIPTION	TO BE CONST.	EXISTING
DISTINCTIVE BOUNDARY LINE		
CURB		
CURB AND GUTTER		
CONCRETE SIDEWALKS/WALKWAYS	A A A	
GENERATOR CONRETE PAD 6" CONC. SLAB W/ #5 @ 12" O.C. E.W O/ 6" OF CLASS II AGG. BASE ROCK (SEE STRUCTURAL PLAN)		
NEW AC PAVEMENT - TRAFFIC (3" AC ON 9" CLASS 2 AB ON 6" RECOMPACTED SUBGRADE (95%))		
AREA DRAIN		O AD
DRAIN WATER LEADER		o RWL
GAS LINE		—— G —
RECYCLE WATER LINE	—— RW ——	RW
COMMUNICATION LINE		COM
ELECTRICAL LINE	—— Е ——	— Е —
STORM DRAIN CLEANOUT		o SDC
SANITARY SEWER CLEANOUT		o SSC
SAWCUT LINE		
SEE ARCHITECT DRAWING		(S.A.D)
FENCE	x	X




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Key Plan

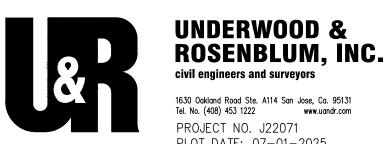

Project Title

B 02_25_26 - RIDDER PARK NORTH & SOUTH BUILDING BACK UP GENERATOR BID SET

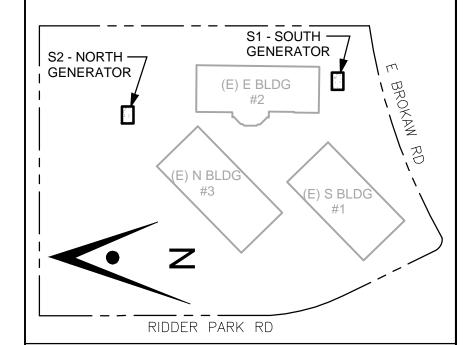1290 RIDDER PARK DR., SAN JOSE CA 95131

SANTA CLARA COUNTY OFFICE OF EDUCATION


No.	Description	Date
1	BID SET	09.05.25

Drawing Title

Consultant Seal

ENLARGED PLAN
N BUILDING
GRADING AND
UTILITY PLAN

Date	Drawing No.
09. 05. 2025	
	00.4
Project Number	C2.1
06451	
	5 7

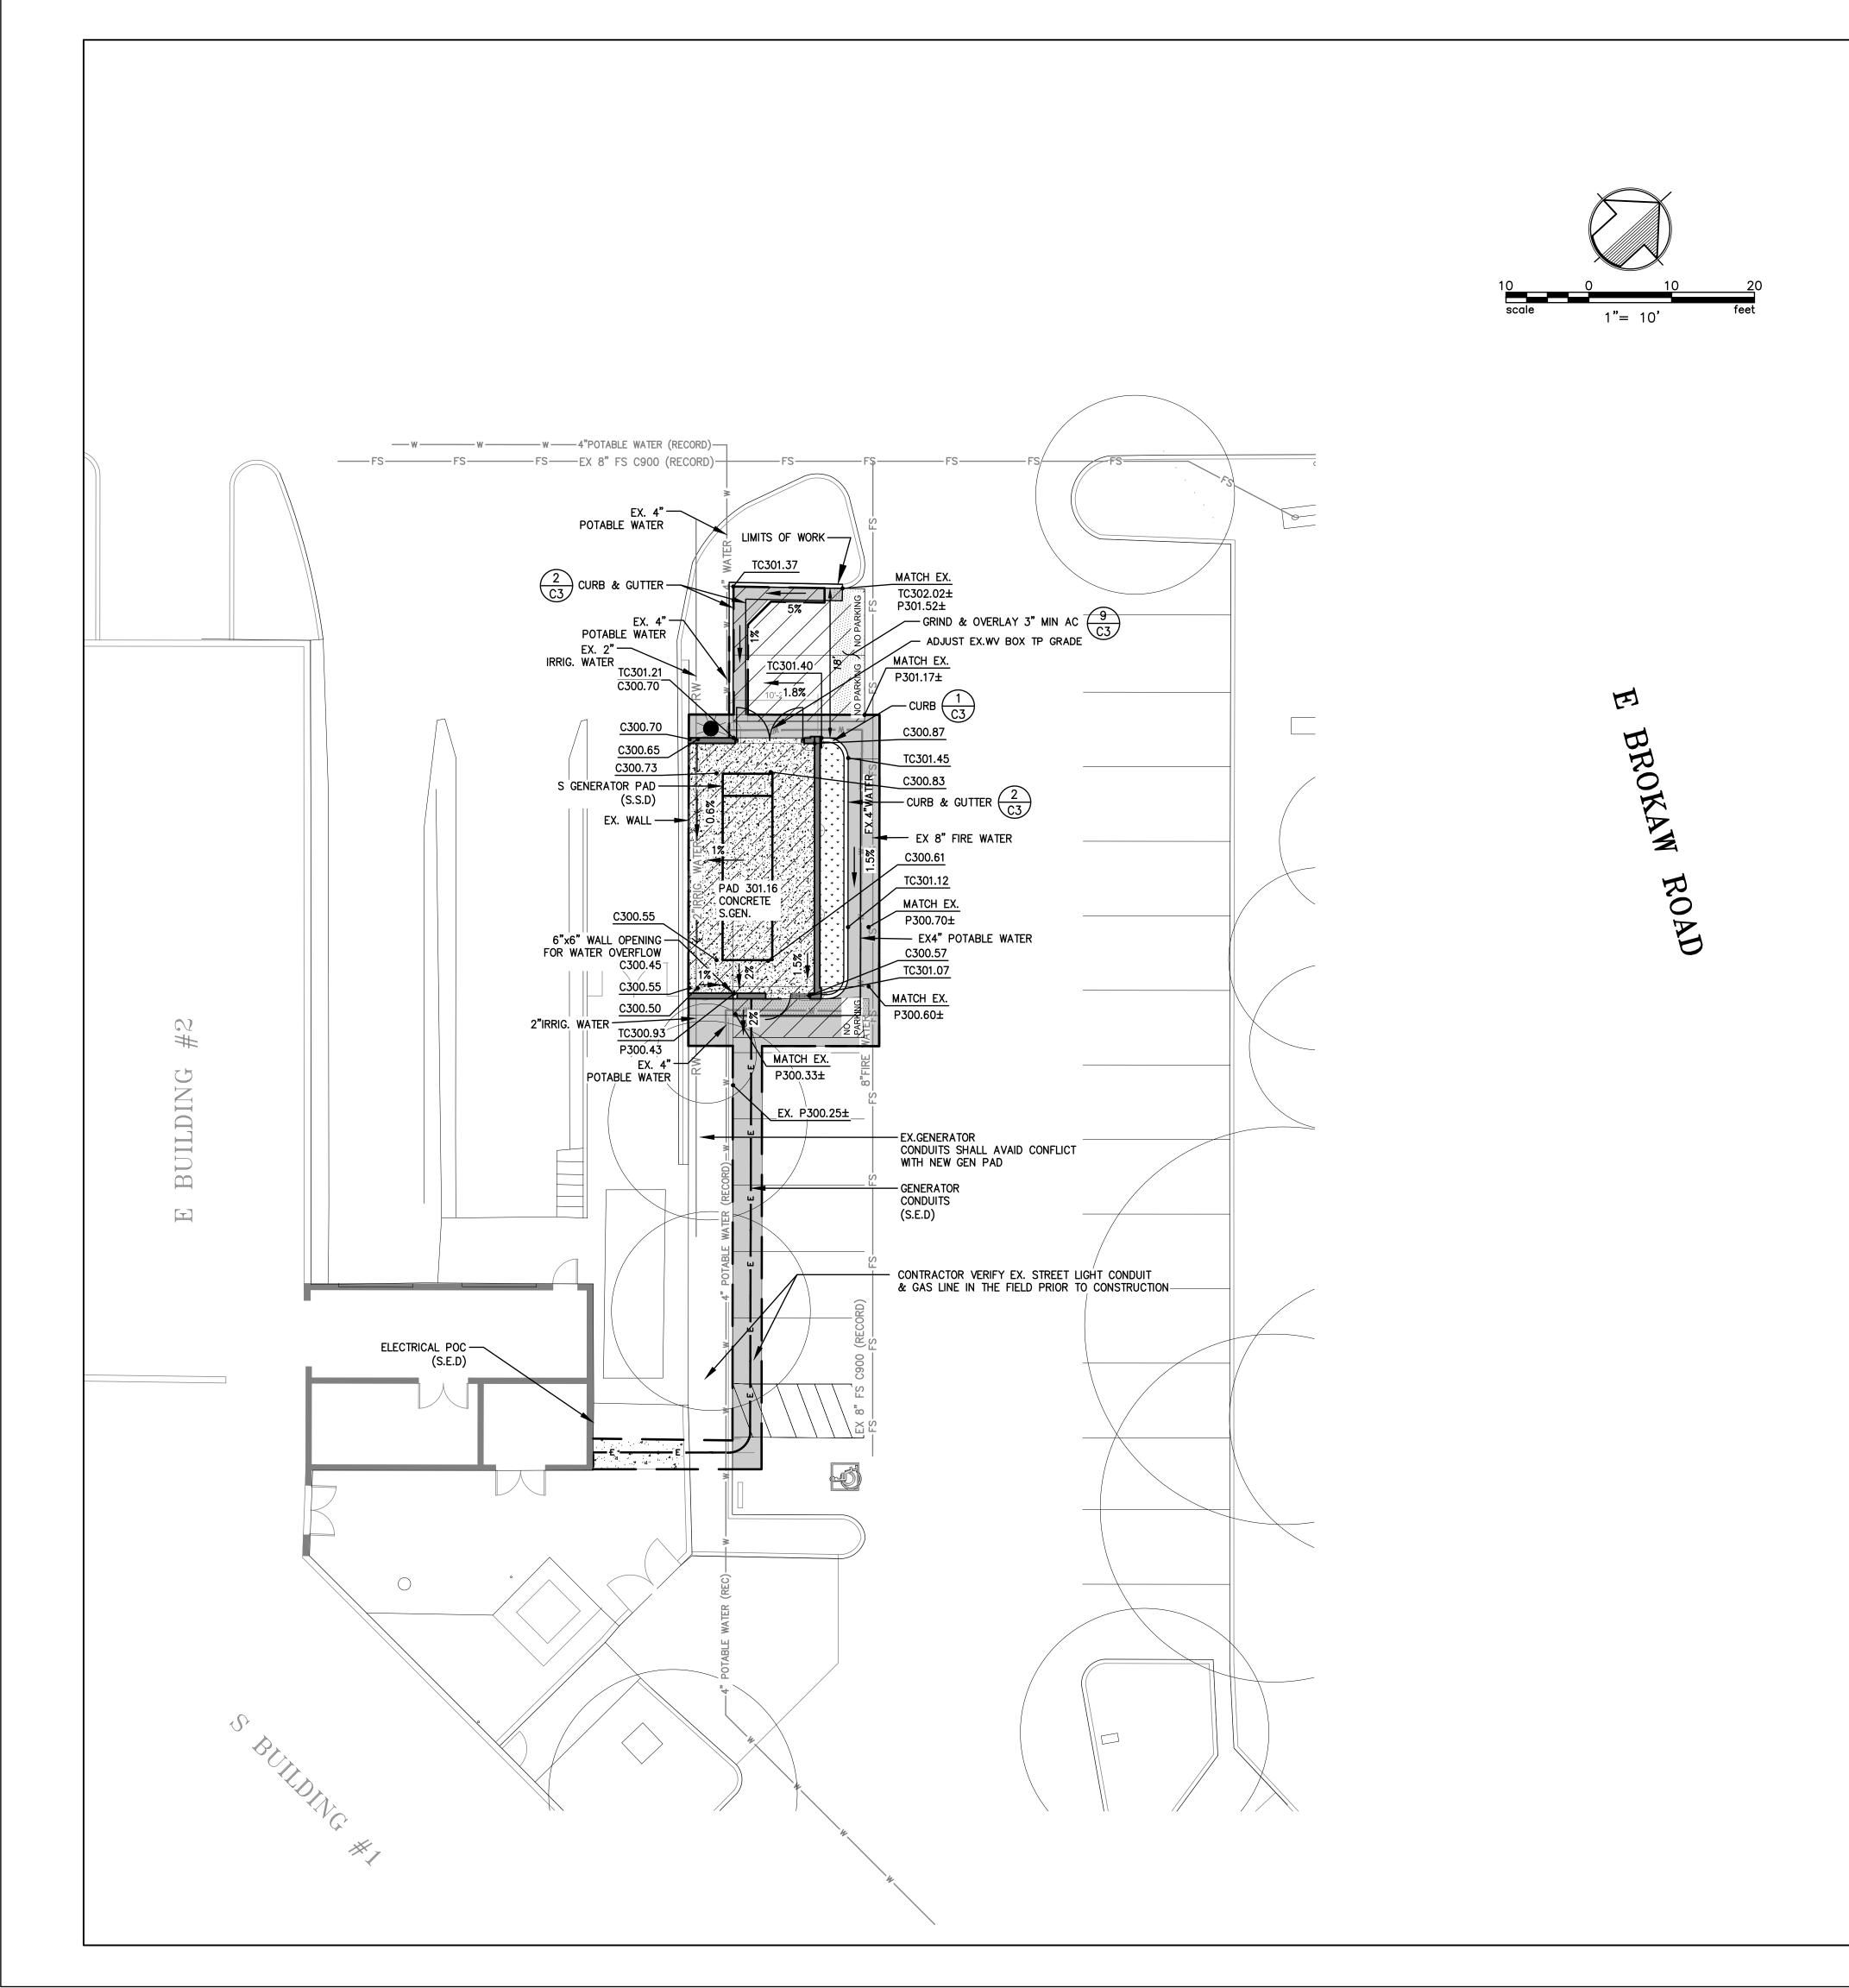



LEGEND

DESCRIPTION

CURB AND GUTTER

DISTINCTIVE BOUNDARY LINE

CONCRETE SIDEWALKS/WALKWAYS

NEW AC PAVEMENT — TRAFFIC (3" AC ON 9" CLASS 2 AB ON 6" RECOMPACTED SUBGRADE (95%))

GENERATOR CONRETE PAD

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ELECTRICAL LINE

SAWCUT LINE

FENCE


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SEE SHEET CO FOR NOTES AND LEGEND

THIS PROJECT WILL NOT CREATE AND/OR REPLACE 5,000 S.F. OF IMPERVIOUS SURFACE AND IS THEREFORE NOT A REGULATED PROJECT AND DOES NOT REQUIRE LOW IMPACT DEVELOPMENT TREATMENT MEASURES.

TO BE CONST.

EXISTING

O AD

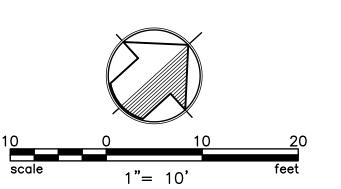o RWL


O SDCO

O SSCO

----- RW -----




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Key Plan

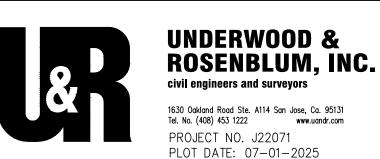

Project Title

B 02_25_26 - RIDDER PARK NORTH & SOUTH BUILDING **BACK UP GENERATOR BID SET**

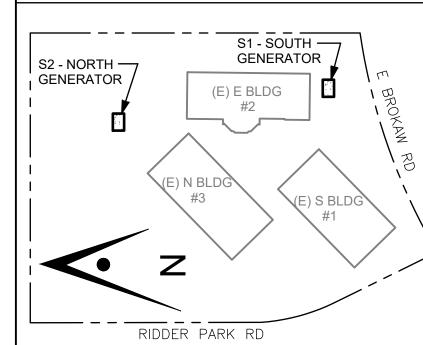1290 RIDDER PARK DR., SAN JOSE CA 95131

SANTA CLARA COUNTY OFFICE OF EDUCATION


No.	Description	Date
1	BID SET	09.05.25

Drawing Title

ENLARGED PLAN S BUILDING GRADING AND UTILITY PLAN

Consultant Seal

Date	Drawing No.
09. 05. 2025	
	000
Project Number	∃ C2.2
06451	

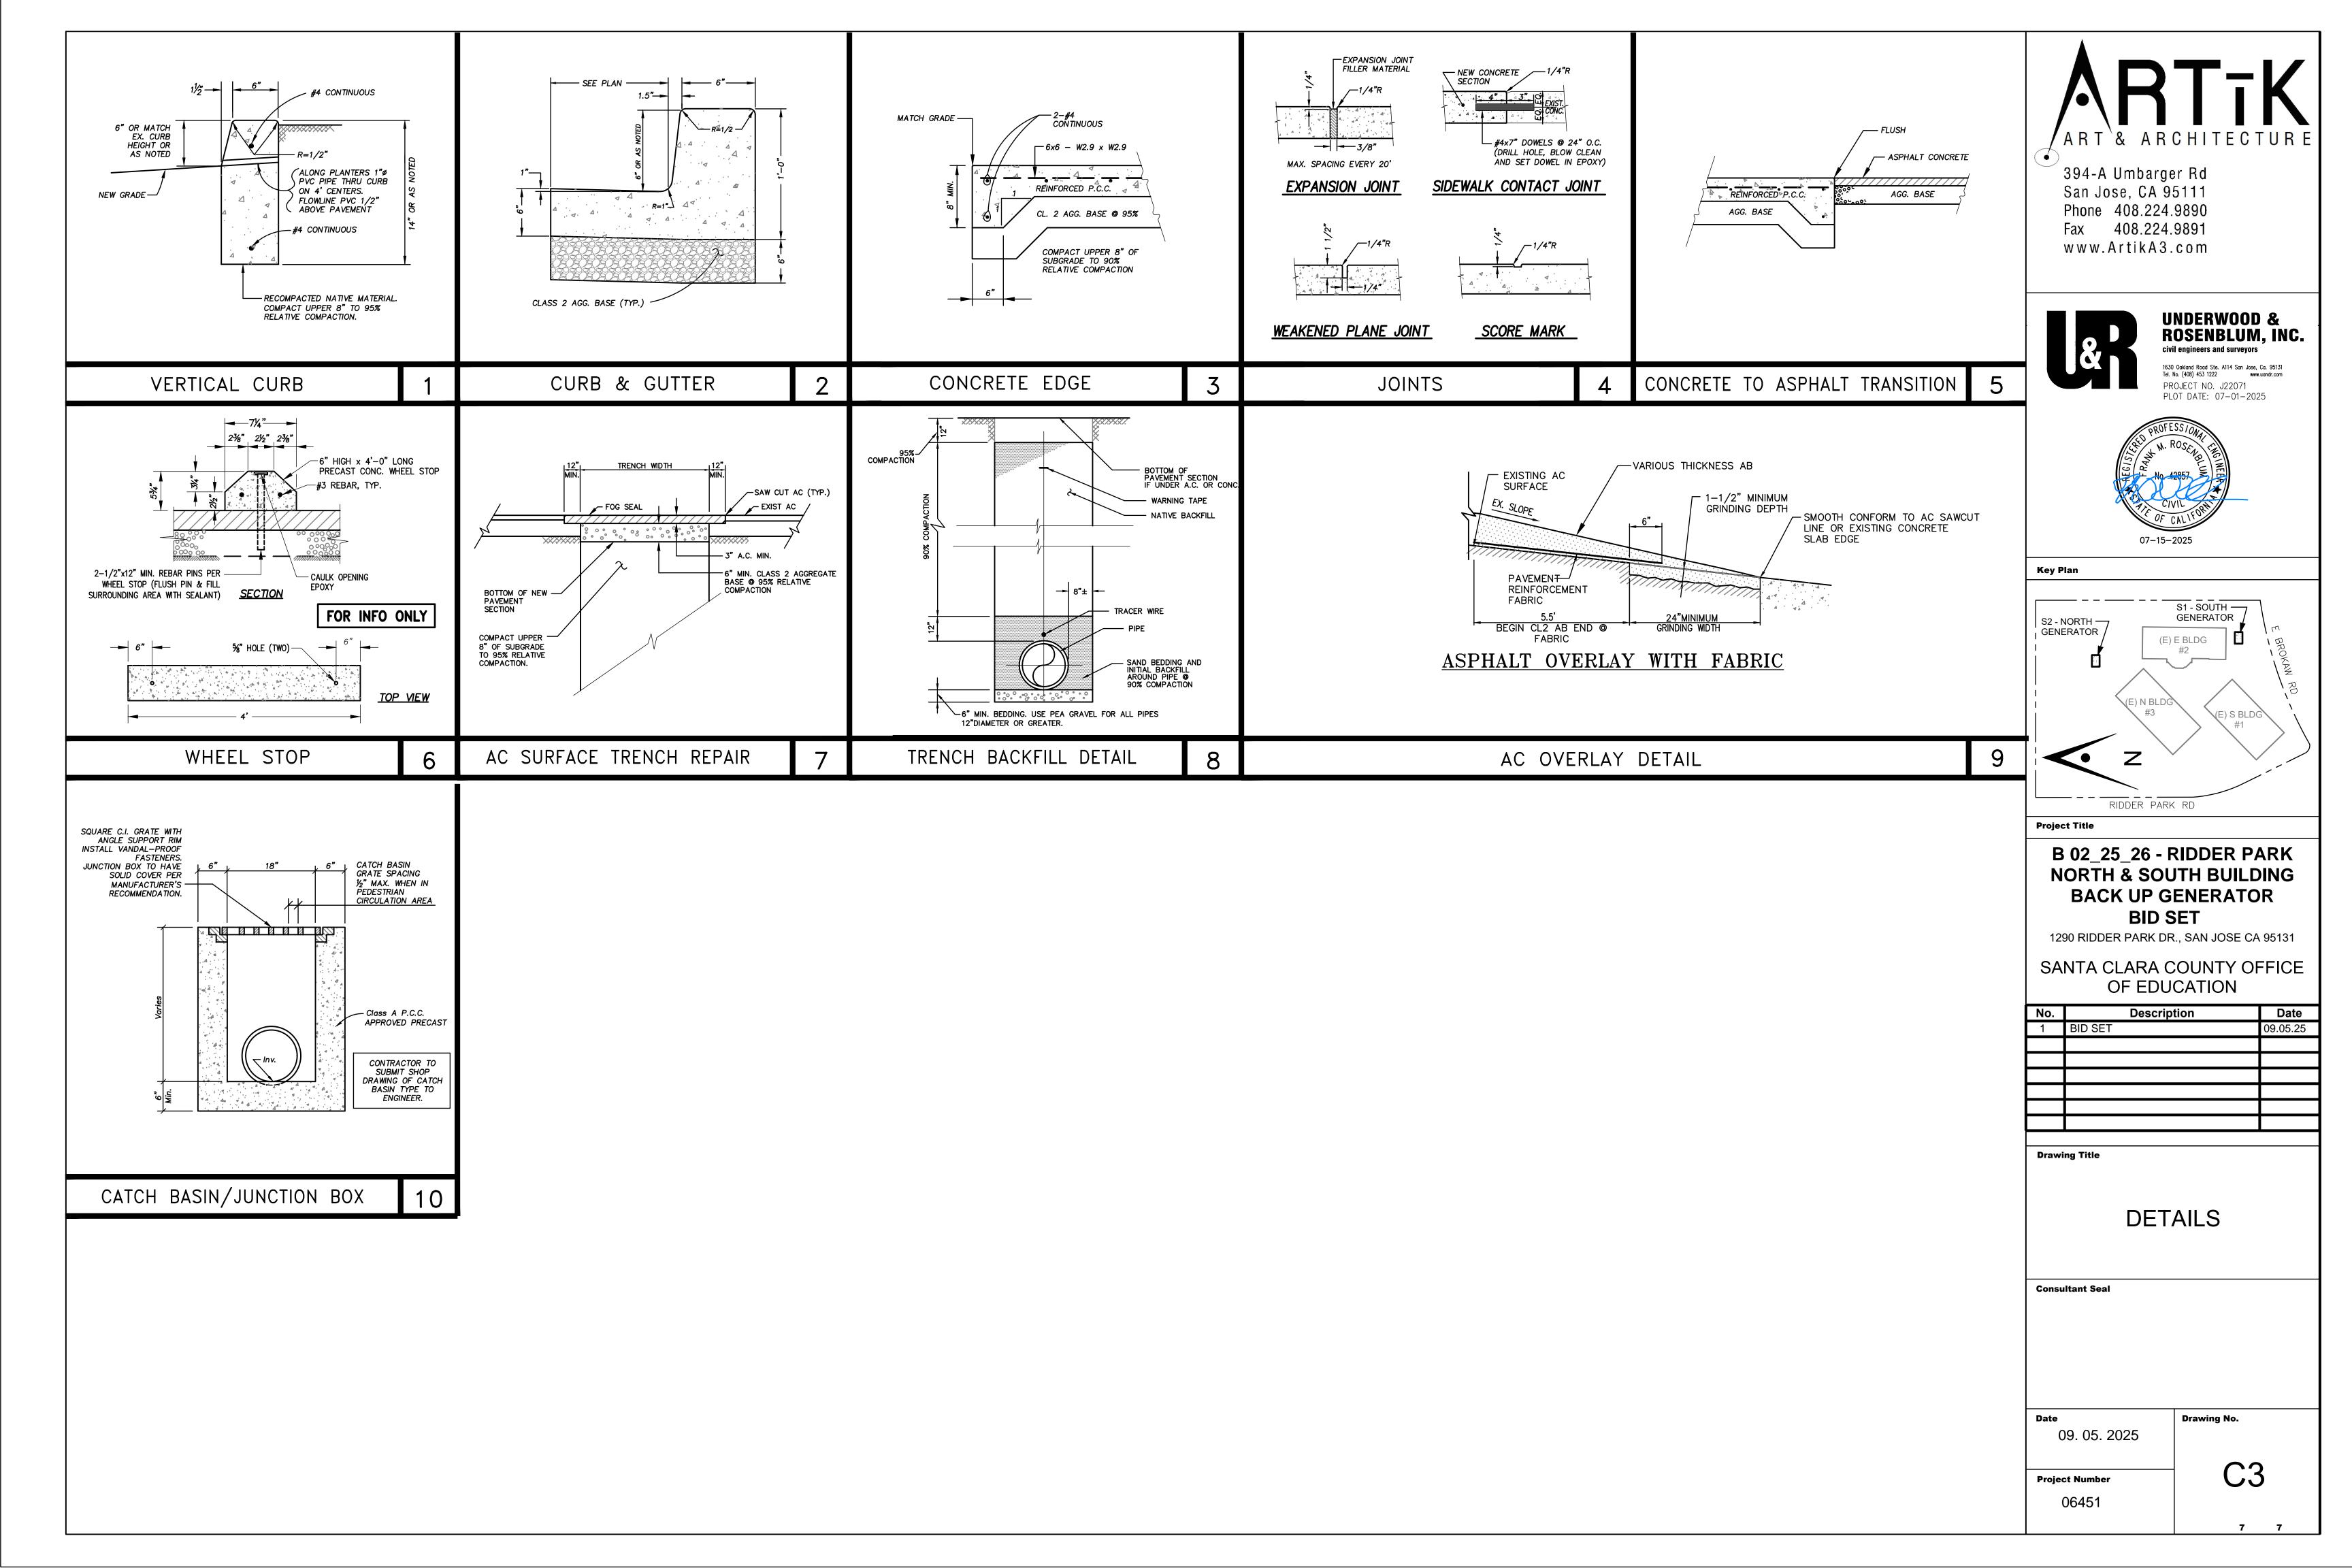

SCCOE BACKUP GENERATOR

SBWR PROJECT ID SJW5072AP2 1290 RIDDER PARK DRIVE SAN JOSE, CA 95131





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COVER SHEET IRRIGATION PLAN L1.2 IRRIGATION DETAILS

SOUTH BAY RECYCLED WATER IRRIGATION NOTES & DETAILS

VICINITY MAP

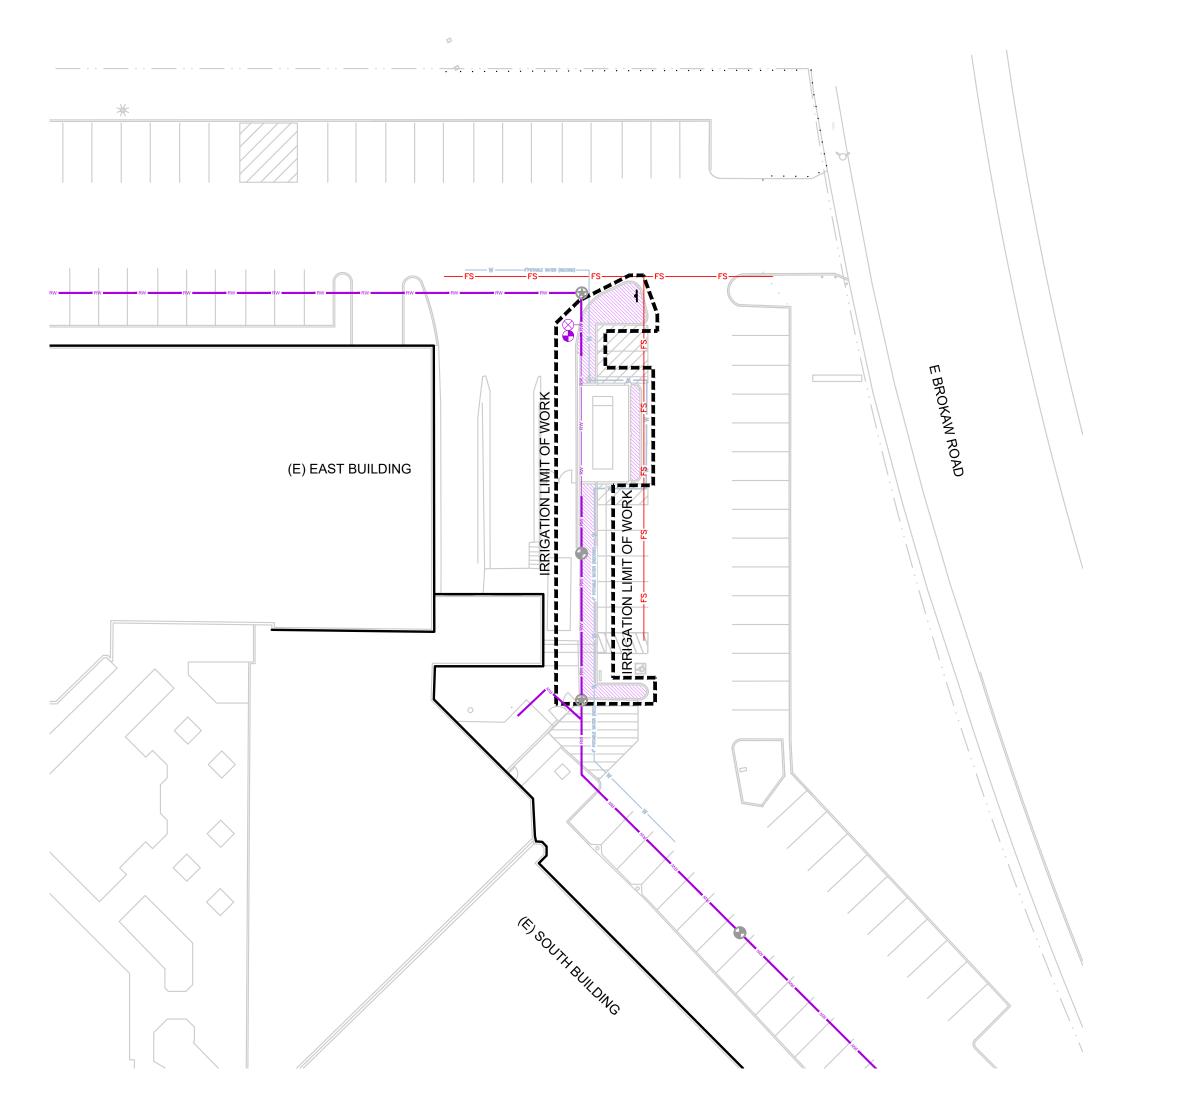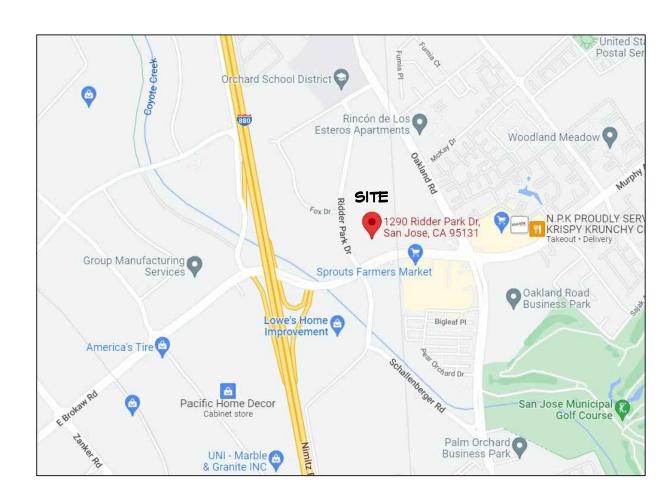

IRRIGATION SCOPE OF WORK

DEMOLISH AND REMOVE PORTION OF RECYCLED MAINLINE AND LATERAL LINES. ADD ONE NEW TIE-IN TO EXISTING RECYCLED WATER MAINLINE. INSTALL (1) VALVE, LATERAL LINES, AND LOW-FLOW BUBBLERS TO NEW SHRUB PLANTING. NO POTABLE WATER LINES ARE EFFECTED BY THE SCOPE OF THIS PROJECT. RECYCLED WATER IRRIGATION LINES DO NOT CROSS DOMESTIC WATER LINES WITHIN THE LIMIT OF WORK.

GENERAL SITE INFORMATION FOR RECCLED WATER USE: (SJW5072AP2)

- 1. LANDSCAPED RECYCLED WATER IRRIGATION USE AREA: 765 SQ. FT. 2. PUBLIC ACCESS TO SITE GROUNDS IS: UNRESTRICTED
- 3. OWNER: SCCOE
- 4. PROPERTY MANAGER CONTACT: STEPHANIE GOMEZ, (408) 453-6519,
- SGOMEZ@SCCOE.ORG
- 5. TENANT: NOT APPLICABLE 6. ON-SITE WELL LOCATIONS: NONE
- 7. WELLS ON ADJACENT SITES LOCATED WITHIN 50 FT. OF RECYCLED WATER APPROVED USE AREA OR WITHIN 100 FT. OF ANY RECYCLED WATER IMPOUNDMENT:
- 8. OUTDOOR DRINKING FOUNTAINS IN/NEAR THE RECYCLED WATER APPROVED USE
- 9. OUTDOOR EATING AREA(S) IN/NEAR THE RECYCLED WATER APPROVED USE AREA:
- 10. WATER FEATURES ON SITE: NONE



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B 02_25_26 - RIDDER PARK NORTH & SOUTH BUILDING BACK UP GENERATOR **BID SET**

1290 RIDDER PARK DR., SAN JOSE CA 95131

SANTA CLARA COUNTY OFFICE OF EDUCATION

No.	Description	Date
1	BID SET	09.05.25

Drawing Title

IRRIGATION COVER SHEET

Architect Seal

File Number Drawing No


ANLA: 2210

Application Number 09. 05. 2025

SCALE: 1" = 30'-0"

NEW IRRIGATED LANDSCAPE AREA EXISTING RECYCLED WATER METER TO REMAIN NEW RECYCLED WATER REMOTE CONTROL VALVE EXISTING EXTERIOR WALL MOUNT CONTROLLER, RECYCLED WATER, TO REMAIN EXISTING RECYCLED WATER CONSTANT PRESSURE MAINLINE NEW RECYCLED WATER CONSTANT PRESSURE MAINLINE EXISTING POTABLE WATER PIPE PER CIVIL SURVEY PROPOSED POTABLE WATER PIPE EXISTING FIRE LINE PER CIVIL SURVEY

SITE IRRIGATION LEGEND

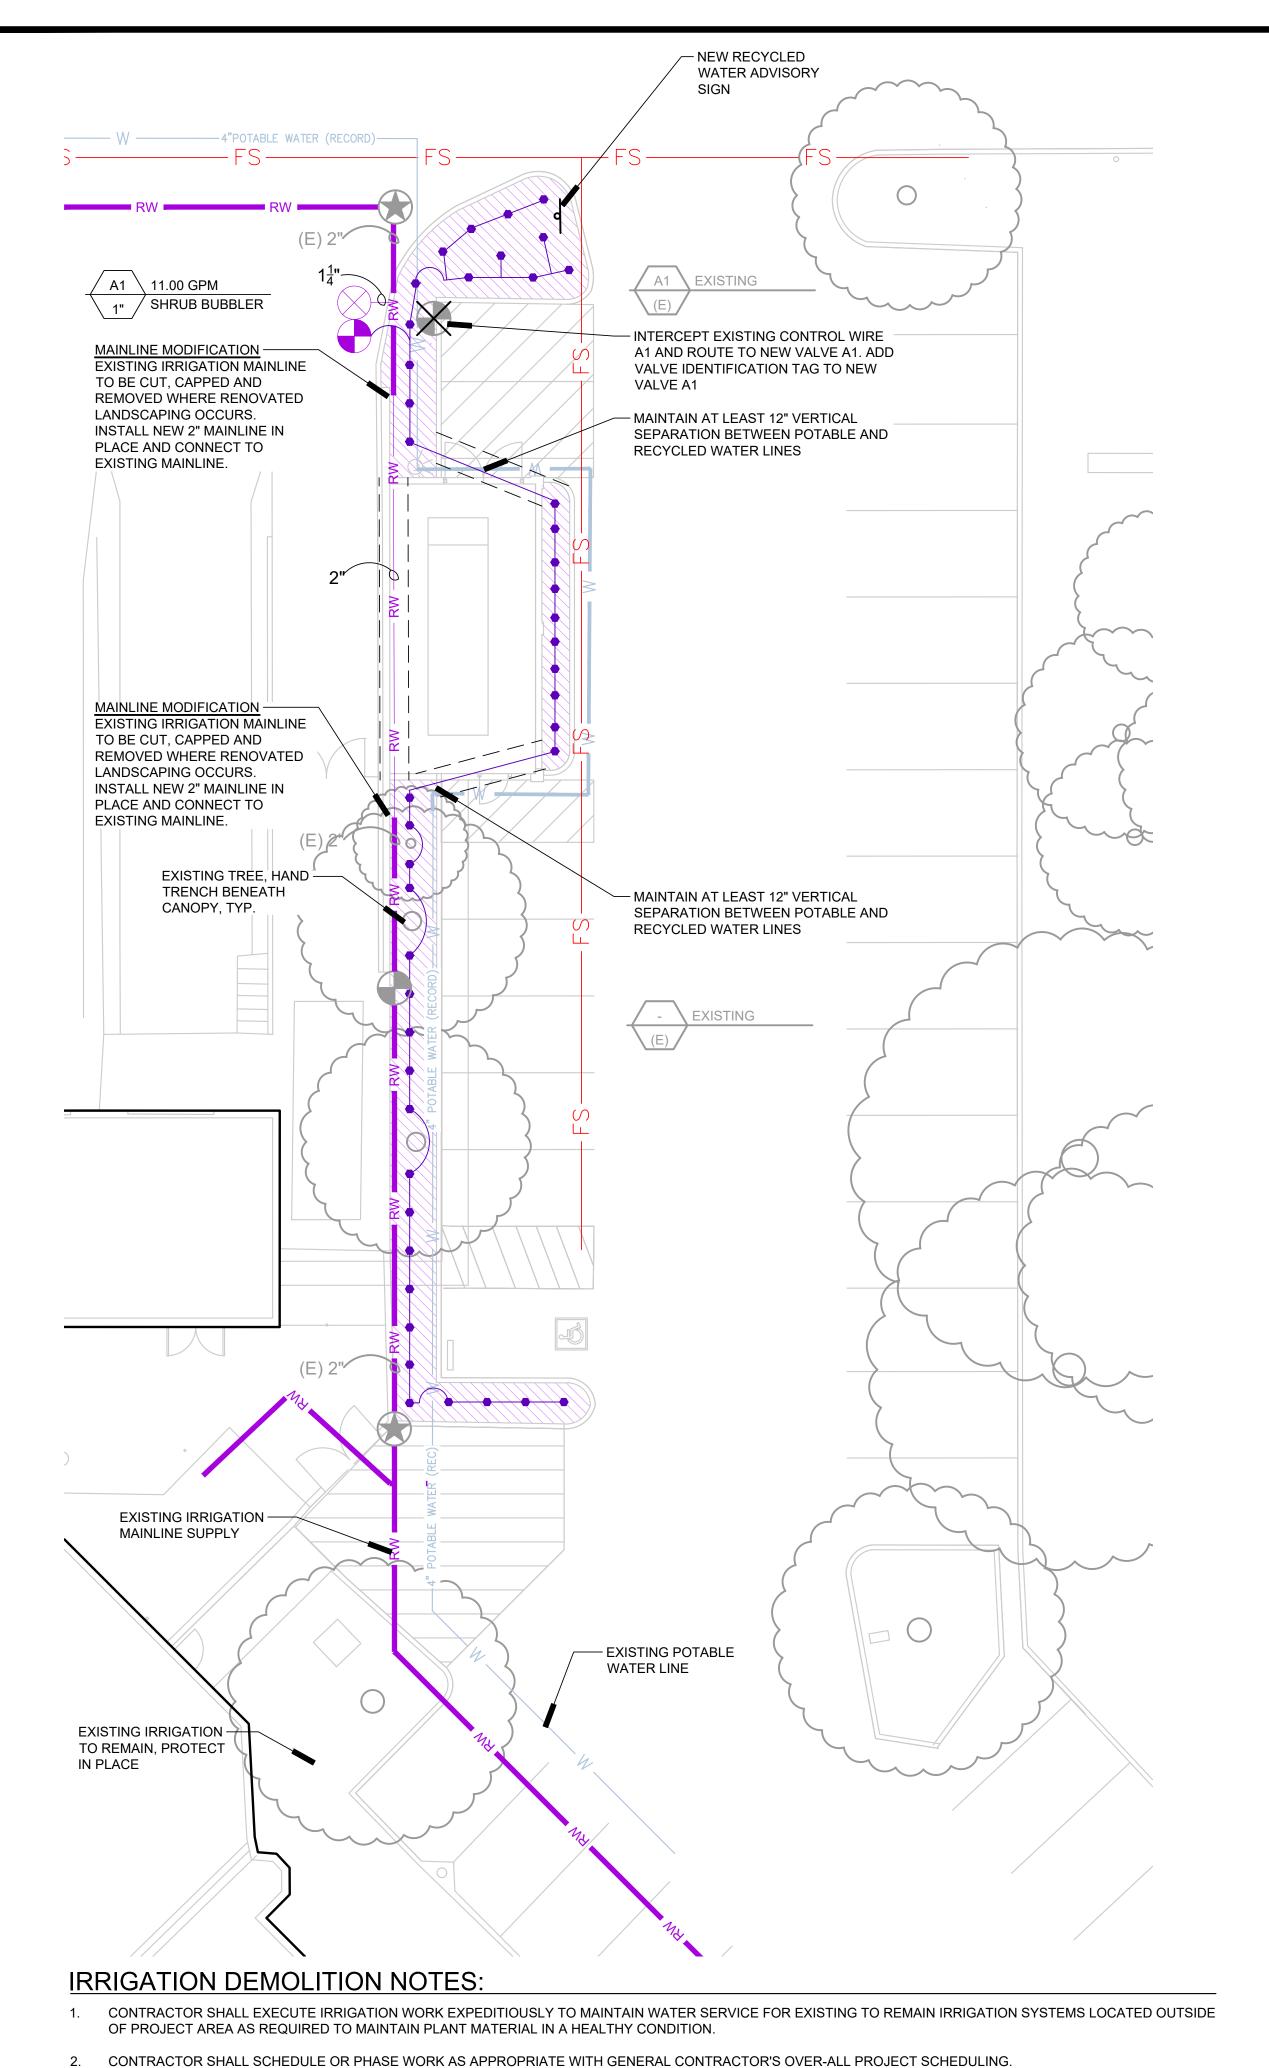

IRRIGATION NOTES

- 1. THESE NOTES ARE FOR GENERAL REFERENCE IN CONJUNCTION WITH AND AS A SUPPLEMENT TO THE WRITTEN SPECIFICATIONS, DETAILS, ADDENDA AND CHANGE ORDERS ASSOCIATED WITH THE CONTRACT DOCUMENTS.
- 2. CONTRACTOR SHALL BECOME FAMILIAR WITH THE LOCATION OF EXISTING AND PROPOSED UNDERGROUND SERVICES. CONTACT UNDERGROUND SERVICE ALERT (USA) AT (800) 642-2444 PRIOR TO BEGINNING WORK. CONTACT OWNER'S REPRESENTATIVE SHOULD ANY CONFLICTS ARISE.
- 3. THE IRRIGATION SYSTEM SHALL BE INSTALLED IN ACCORDANCE WITH LOCAL CODES AND REGULATIONS. CONTRACTOR TO CONFORM TO THE REQUIREMENTS OF NFPA 24, SECTION 8.1, MINIMUM 'DEPTH-OF-COVER' (36 INCHES) FOR PIPE TO INCLUDE FIRE LANE ROUTES OF ACCESS.
- 4. THIS SYSTEM IS DESIGNED TO OPERATE AT 60 PSI AND 11.00 GPM FROM THE POINT OF CONNECTION. CONTRACTOR SHALL VERIFY PRESSURE AND FLOW PRIOR TO BEGINNING OF WORK. CONTACT OWNER'S REPRESENTATIVE IMMEDIATELY SHOULD CONFLICTS ARISE.
- 5. THE IRRIGATION SYSTEM DESIGN IS DIAGRAMMATIC. WHERE PIPING, VALVES, ETC. ARE SHOWN OUTSIDE OF PLANTING AREAS, THE INTENT IS FOR PIPING, VALVES, ETC. TO BE INSTALLED WITHIN PLANTING AREAS UNLESS OTHERWISE NOTED AND DETAILED.
- 6. CONTRACTOR SHALL COORDINATE IRRIGATION INSTALLATION WITH OTHER TRADES. CONTRACTOR TO COORDINATE AND VERIFY ALL SLEEVING, PIPING, ELECTRICAL SUPPLY, POINT OF CONNECTION, ETC.
- 7. CONTRACTOR IS RESPONSIBLE FOR COMPLETE AND UNIFORM COVERAGE OF PLANTING AND TURF AREAS. CONTRACTOR TO THROTTLE THE FLOW CONTROL AT EACH VALVE TO OBTAIN OPTIMUM OPERATING PRESSURE FOR EACH CIRCUIT. ADJUST SPRAY HEADS AND NOZZLES FOR OPTIMUM COVERAGE WHILE PREVENTING OVERSPRAY ONTO WALKWAYS AND STRUCTURES. ADDITIONALLY, CONTRACTOR SHALL ADJUST ALL VALVES, NOZZLES, AND HEADS FOR OPTIMUM COVERAGE, AVOIDING MISTING, OVERSPRAY, OR UNDERSPRAY.
- 8. LATERAL LINES TO BE SIZED PER PIPE SIZING CHART.
- 9. CONTRACTOR TO MAINTAIN AS-BUILT DRAWING SET TO BE AVAILABLE ON SITE AT ALL TIMES AND AT TIME OF SUBSTANTIAL COMPLETION REVIEW. CONTRACTOR SHALL PREPARE REDUCED, COLOR-CODED PLANS, LAMINATE, AND PLACE (1) IN CONTROLLER ENCLOSURE AND DELIVER (1) TO OWNER'S REPRESENTATIVE AFTER APPROVAL OF RECORD DRAWING SUBMITTAL AND PRIOR TO FINAL COMPLETION.
- 10. CONTRACTOR SHALL EXERCISE EXTREME CAUTION WHEN TRENCHING AROUND EXISTING TREES AND SHRUBS. CONTRACTOR SHALL HAND TRENCH WHEN TRENCHING ACROSS ROOTS 2" AND LARGER TO PRESERVE ROOT SYSTEM. ROOTS SMALLER THAN 2" MAY BE TRIMMED. DO NOT TEAR ANY ROOTS.
- 11. THE CONTRACTOR SHALL BE RESPONSIBLE UNDER THIS CONTRACT FOR REPAIRING OR REPLACING, AT THEIR OWN EXPENSE, ANY STRUCTURES, FENCES, WALLS, PLANT MATERIAL OR TREES DAMAGED OR DESTROYED, BOTH ON THIS PROPERTY OR THOSE PROPERTIES ADJACENT TO THIS SITE. THE DAMAGED ITEM(S) WILL BE RESTORED TO THEIR ORIGINAL CONDITION OR REPLACED TO THE SATISFACTION OF THE OWNER'S REPRESENTATIVE.
- 12. EXISTING IRRIGATION CONTROLLER IS LOCATED ON THE EAST SIDE OF BUILDING IN UTILITY YARD.
- 13. REFER TO SPECIFICATIONS SECTION AND IRRIGATIONS DETAILS ON SHEETS L1.2 AND L1.3.
 015639 TEMPORARY TREE AND PLANT PROTECTION
 328400 PLANTING IRRIGATION
- 14. CONTRACTOR TO HIRE 3RD PARTY CROSS-CONNECTION SPECIALIST TO PERFORM REQUIRED CROSS-CONNECTION TEST.

IRRIGATION LEGEND

SYM MODEL	MANUF.	DESCRIPTION	GPM	PSI	RAD
	-	RECYCLED WATER ADVISORY SIGN, DETAIL RW-36, L3.3	0.25	30	-
BUBBLERS					
PCB-25-R	HUNTER	FLOOD BUBBLER - ONE PER SHRUB, PER DETAIL	0.25	30	-
VALVES					
	-	EXISTING REMOTE CONTROL VALVE TO REMAIN			
_	-	EXISTING REMOTE CONTROL VALVE TO BE REMOVED			
& .	-	EXISTING QUICK COUPLING VALVE			
	AQUA	1/4"-2" BRONZE BODY BALL VALVE, LINE SIZE			
PESBR-PRS-D	RAINBIRD	ELECTRIC PRESSURE COMPENSATING REMOTE CONTROL VALVE, SIZE PER PLAN. AN ASTERISK (*) DENOTES TO INSTALL A "Y" FILTER UPSTREAM OF THE VALVE FOR FLOWS LESS THAN 5.0 GPM.			
PIPING					
RW RW RW EXISTING IRRIGATION MAINLINE TO REMAIN, CONTRACTOR TO FIELD-V		D-VER	IFY		
	- RW	SCH 40 (UP TO 1-1/2") CLASS 315 (2" TO 4") PVC PRESSURIZED MAINLINE, PURPLE COLOR, NSF APPROVED, SIZE PER PLAN, DEPTH TO BE 24" IN PLANTING AREAS AND 36" BELOW PAVED AREAS.			
		SCHEDULE 40 PVC NON-PRESSURIZED LATERAL LINE, PURPLE COLOR, DEPTH TO BE 18". NSF APPROVED, SIZE PER CHART			

UTILITY LEGEND

SYMBOL	DESCRIPTION
	EXISTING POTABLE WATER PIPE PER CIVIL SURVEY
w	PROPOSED POTABLE WATER PIPE
———FS———	EXISTING FIRE LINE PER CIVIL SURVEY

SOUTH BAY RECYCLED WATER USE ZONES:

BUBBLER IRRIGATION

SEE SHEET L1.3 FOR SOUTH BAY WATER RECYCLING STANDARD NOTES AND DETAILS

LATERAL PIPE SIZE CHART, SCH 40 PVC B = V

GALLONS PER MINUTE PIPE SIZE

0 - 7 GPM 3/4"

7.01 - 12 GPM 1"

12.01 - 22 GPM 1-1/4"

22.01 - 30 GPM 1-1/2"

30.01 - 50 GPM 2"

50.01 - 70 GPM 2-1/2"


70.01 - 110 GPM 3"

C = GALLONS PER MINUTE ——
A = VALVE NUMBER ————

ALVE NUMBER —	
ALVE SIZE	
ESCRIPTION —	_/ A \ C
	B D

DDW ACCEPTANCE SIGNATURES FOR SBWR PROJECT ID SJW5072AP2


SBWR - SOUTH BAY WATER RECYCLING
DATE:

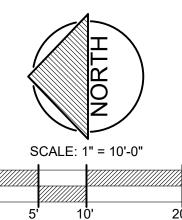



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Consultant

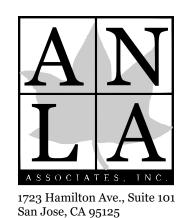

T. 408.292.2196

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Signature

03.31.2027

Renewal Date

05.28.2025

Date

Key Plan

Project

B 02_25_26 - RIDDER PARK NORTH & SOUTH BUILDING BACK UP GENERATOR BID SET

1290 RIDDER PARK DR., SAN JOSE CA 95131

SANTA CLARA COUNTY OFFICE OF EDUCATION

No.	Description	Date
1	BID SET	09.05.25

Drawing Title

IRRIGATION PLAN

Architect Seal

File Number Drawing No

ANLA: 2210

Application Number

Date
09. 05. 2025

Project No. 06401


CONTRACTOR SHALL NOTIFY AND COORDINATE WITH SITE LANDSCAPE SUPERVISOR IN ADVANCE OF PLANNED DISRUPTIONS OF IRRIGATION WATER SERVICE.

REPAIRED BY INSTALLING NEW SOD.

IRRIGATION CONTRACTOR SHALL INCLUDE IN THEIR BID TO COORDINATE WITH GENERAL CONTRACTOR PRIOR TO DEMOLITION AND GRADING AND MAKE

TEMPORARY AND PERMANENT CONNECTIONS AND / OR REPAIRS AS NECESSARY TO MAINTAIN IRRIGATION WATER SERVICE TO IRRIGATION SYSTEMS LOCATED OUTSIDE OF PROJECT AREA AFFECTED BY CONSTRUCTION. CONTRACTOR TO MAINTAIN WATER SUPPLY TO PLANTS AND TURF AT ALL TIMES OR SUPPLY WATER


MANUALLY TO MAINTAIN PLANTS AND TURF IN HEALTHY CONDITION THROUGHOUT CONSTRUCTION. DAMAGE TO TURF DUE TO INSUFFICIENT WATER SHALL BE

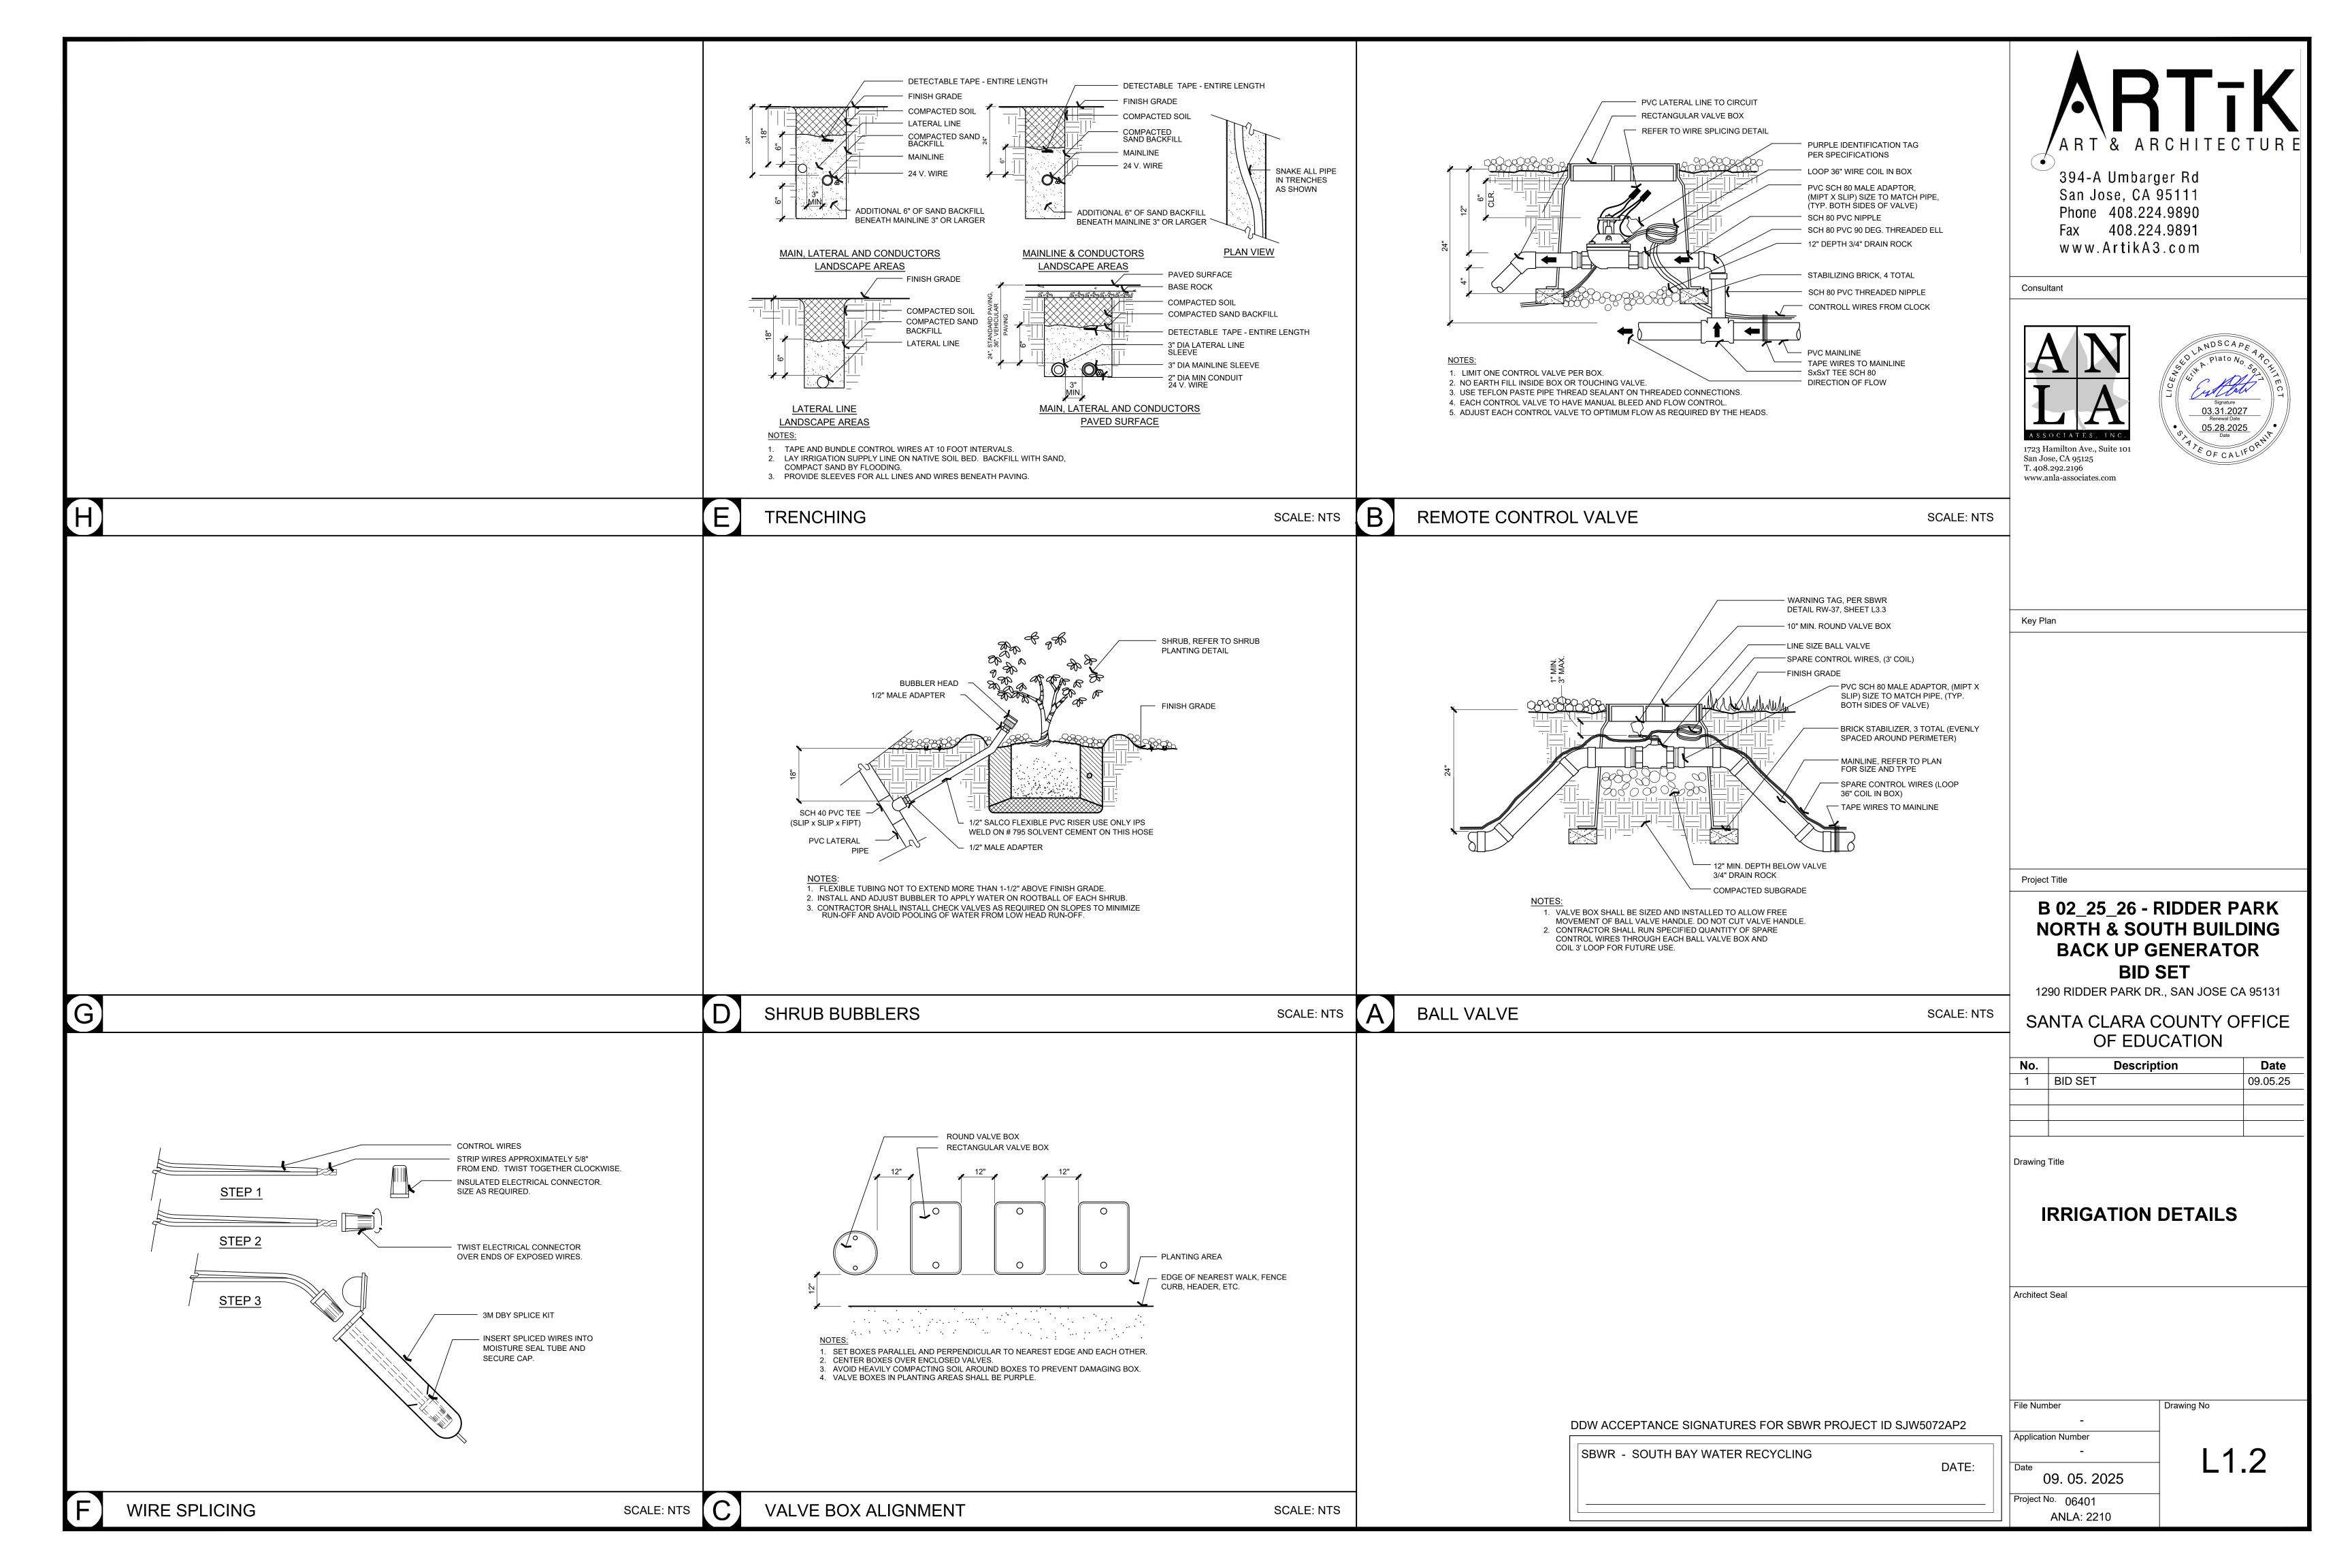

SOUTH BAY WATER RECYCLING (SBWR) STANDARD NOTES FOR **RECYCLED WATER SYSTEMS:**

CROSS-CONNECTION SPECIALIST:

- 1. PRIOR TO RECEIVING RECYCLED WATER, THE SITE MUST BE PERMITTED BY SOUTH BAY WATER RECYCLING
- A. INSPECTION BY SBWR HAS BEEN COMPLETED SHOWING CONFORMANCE WITH SBWR RULES AND REGULATIONS (https://www.sanjoseca.gov/home/showdocument?id=526);
 B. A FINAL ON-SITE INSPECTION HAS BEEN CONDUCTED TO CONFIRM THAT ALL REQUIREMENTS HAVE
- C. THE CUSTOMER HAS PROVIDED THE SBWR INSPECTOR WITH THE MOST CURRENT BACKFLOW PREVENTION DEVICE TEST REPORTS FOR ALL OF THE SITE'S POTABLE WATER AND FIRE SERVICE
- CONNECTIONS (AND ANY AUXILIARY WATER SOURCES). D. SITE HAS PASSED REQUIRED CROSS-CONNECTION TEST PERFORMED BY A CERTIFIED AWWA
- THE OWNER'S OR TENANT'S REPRESENTATIVE MUST ALSO COMPLETE A SITE SUPERVISOR TRAINING CLASS OFFERED BY SBWR IN ORDER TO RECEIVE A PERMANENT PERMIT. IN THE INTERIM BETWEEN CONNECTION AND TRAINING, THE TENANT OR OWNER WILL RECEIVE A TEMPORARY RECYCLED WATER PERMIT.
- CONTACT SBWR AT (408) 277-3671 FOR FURTHER INFORMATION. 2. ALL WORK SHALL CONFORM TO EXISTING REGULATIONS INCLUDING BUT NOT LIMITED TO:
- SOUTH BAY WATER RECYCLING (SBWR) RULES AND REGULATIONS B. STATE WATER RESOURCES CONTROL BOARD - DIVISION OF DRINKING WATER REGULATIONS
- CHANGES MADE TO THE APPROVED IRRIGATION PLANS SHALL BE SUBMITTED TO SBWR FOR REVIEW AND
- APPROVAL AT LEAST 2 WEEKS PRIOR TO START OF CONSTRUCTION. 4. AT LEAST TWO DAYS PRIOR TO START OF CONSTRUCTION, CONTRACTOR AND SBWR INSPECTOR SHALL HOLD A
- PRE-CONSTRUCTION MEETING. TO SCHEDULE MEETING, CONTACT SBWR AT (408) 277-3671.
- NOTIFY SBWR INSPECTOR A MINIMUM OF AT LEAST 24 HRS BEFORE WORK BEGINS. SBWR INSPECTOR MUST PRESENCE OF PROPER BACKFLOW PREVENTION AT ALL POTABLE POINTS OF CONNECTION;
 - NEW UNDERGROUND PIPING (LABELING, CLEARANCES, BURIAL DEPTH, SLEEVING); INSTALLATION OF SIGNS, TAGS, AND CONTROLLER DECALS;
- REQUIRED TEMPORARY CONNECTION TO POTABLE WATER SERVICE; IN MOST CASES, THE SITE'S IRRIGATION SYSTEM MUST BE CONNECTED TO A TEMPORARY SOURCE OF POTABLE WATER IN ORDER TO CONDUCT REQUIRED CROSS-CONNECTION TEST;
- E. SITE PASSED REQUIRED CROSS-CONNECTION TEST PERFORMED BY A CERTIFIED AWWA CROSS-CONNECTION SPECIALIST:
- F. NEW METER INSTALLATION PRIOR TO RECEIVING RECYCLED WATER, SBWR INSPECTOR MUST INSPECT THE DISCONNECTION OF THE SITE'S IRRIGATION SYSTEM FROM THE TEMPORARY POTABLE WATER SUPPLY, AND THEN INSPECT THE CONNECTION OF THE SYSTEM TO THE RECYCLED WATER
- 6. NO CROSS-CONNECTIONS BETWEEN THE POTABLE AND RECYCLED WATER SYSTEMS ARE PERMITTED.
- ALL ON-SITE BURIED RECYCLED WATER PIPING SHALL BE IDENTIFIED BY ONE OF THE FOLLOWING METHODS: USING PURPLE-COLORED PVC PIPE WITH CONTINUOUS WORDING: "CAUTION – RECYCLED WATER"
- PRINTED ON OPPOSITE SIDES OF THE PIPE: PIPE SHALL BE LAID WITH WORDING FACING UPWARDS: B. WARNING TAPE WITH A MINIMUM WIDTH OF 3 INCHES READING: "CAUTION - RECYCLED WATER" (IN BLACK OR WHITE LETTERING ON PURPLE BACKGROUND) SHALL RUN CONTINUOUSLY ON TOP OF PIPING AND SHALL BE ATTACHED TO PIPING WITH PLASTIC TAPE BANDED AROUND THE WARNING TAPE
- AND THE PIPE EVERY 5 FEET ON CENTER: C. BLUE-COLORED PVC PIPE SHALL NOT BE USED UNLESS THE BLUE COLOR IS COMPLETELY OBSCURED BY ENCASEMENT OF THE PIPE WITH PURPLE POLYETHYLENE WRAP OR OTHER METHODS APPROVED
- 8. PVC PIPE: CONSTANT-PRESSURE MAINLINE PIPING 1 1/2 INCHES AND SMALLER SHALL BE SCHEDULE 40; CONSTANT-PRESSURE MAINLINE PIPING 2 INCHES AND LARGER SHALL BE CLASS 315 OR C900 CLASS 200 DR 14: INTERMITTENT-PRESSURE LATERAL PIPING SHALL BE SCHEDULE 40 OR CLASS 200. BURIED COPPER PIPE SHALL
- 9. ALL ON-SITE RECYCLED WATER PIPING SHALL BE BURIED TO A MINIMUM DEPTH FROM FINISHED GRADE TO TOP OF PIPE (MINIMUM COVER) OF: A. PRESSURIZED LINES 3 INCHES AND LARGER PRESSURIZED LINES 2 1/2 INCHES AND SMALLER
- INTERMITTENT-PRESSURE LINES 10. ALL RECYCLED WATER PIPING OTHER THAN PVC PIPING WITH SOLVENT WELDED JOINTS SHALL BE PROTECTED AGAINST MOVEMENT WITH THRUST BLOCKS OR RESTRAINED JOINTS OR OTHER APPROVED METHOD PER SBWR
- 11. MAINTAIN A 10-FOOT HORIZONTAL SEPARATION BETWEEN BURIED PRESSURIZED RECYCLED WATER IRRIGATION PIPING AND BURIED POTABLE WATER PIPING UNLESS OTHERWISE NOTED. AT PIPE CROSSINGS, BURIED PRESSURIZED RECYCLED WATER IRRIGATION PIPING MUST BE 12 INCHES BELOW POTABLE WATER LINES. PRESSURIZED RECYCLED WATER PIPELINES ARE ALLOWED OVER POTABLE WATER PIPELINES WITH A MINIMUM OF 12 INCHES VERTICAL SEPARATION IF A FULL STANDARD PIPE LENGTH IS CENTERED OVER THE CROSSING, OR THE RECYCLED WATER PIPELINE IS INSTALLED IN A PIPE SLEEVE WHICH EXTENDS A MINIMUM OF 10 FEET ON EITHER SIDE OF THE POTABLE WATER PIPING. INTERMITTENTLY PRESSURIZED IRRIGATION LATERALS MAY BE LOCATED A MINIMUM OF 12 INCHES ABOVE POTABLE WATER PIPELINES WITHOUT SLEEVING.
- 12. ALL RECYCLED WATER SYSTEM REMOTE CONTROL VALVES, ISOLATION VALVES, QUICK COUPLING VALVES, STRAINERS, AND PRESSURE REDUCING VALVES SHALL BE INSTALLED BELOW GRADE IN VALVE BOXES. LIDS SHALL PERMANENTLY READ "RECYCLED WATER." GREEN, BLACK, OR PURPLE-COLORED PLASTIC BOXES AND LIDS, AND CONCRETE BOXES WITH CONCRETE OR METAL LIDS ARE ACCEPTABLE. FOR PLASTIC BOX LIDS, LETTERING SHALL BE IMPRINTED ON LID OR APPLIED USING A NAMEPLATE ATTACHED ONTO THE LID WITH RIVETS, SCREWS, OR BOLTS. FOR CONCRETE LIDS, LETTERING SHALL BE IMPRINTED ON LID FROM FACTORY FOR CAST IRON AND METAL CHECKER PLATE LIDS, LETTERING MUST BE BEAD-WELDED OR PERMANENTLY
- 13. QUICK COUPLING VALVES SHALL HAVE PURPLE COVERS AND SHALL BE PER SBWR STANDARD DETAILS.
- 14. NO HOSE BIBS ARE ALLOWED ON THE RECYCLED WATER IRRIGATION SYSTEM. ANY EXTERIOR HOSE BIBS SERVED WITH POTABLE WATER MUST BE LABELED PER SBWR STANDARD DETAILS.
- 15. ALL RECYCLED WATER METERS, DEVICES, AND VALVES E.G. ISOLATION VALVES, IRRIGATION CONTROLLERS, REMOTE CONTROL VALVES, PRESSURE REDUCING VALVES, QUICK COUPLING VALVES, FLOW SENSORS, ETC. -SHALL BE TAGGED PER SBWR STANDARD DETAILS.
- I6 LABEL ALL POTABLE WATER METERS AND ABOVE GROUND POTABLE WATER PIPES/ DEVICES (BACKELOW PREVENTERS, HOSE BIBS, ETC.) WITH TAGS OR LABELS READING: "POTABLE WATER" IN BLACK LETTERS ON BLUE BACKGROUND, PER SBWR DETAILS.
- 17. ALL RECYCLED WATER IRRIGATION SYSTEMS SHALL HAVE THE FOLLOWING: A. A SWING CHECK VALVE INSTALLED AS CLOSE AS PRACTICABLE TO THE RECYCLED WATER METER BOX
- (UNLESS OTHERWISE DIRECTED BY SBWR). B. A WYE STRAINER (WITH A 20-MESH OR FINER SCREEN) INSTALLED IMMEDIATELY DOWNSTREAM OF THE SWING CHECK VALVE (IF NO SWING CHECK VALVE REQUIRED, THEN AS CLOSE AS PRACTICABLE TO
- THE RECYCLED WATER METER BOX). C. A PRESSURE REDUCING VALVE INSTALLED IMMEDIATELY DOWNSTREAM OF THE STRAINER (UNLESS
- D. THESE COMPONENTS SHALL BE INSTALLED WITH ISOLATION VALVES TO FACILITATE MAINTENANCE.
- 18. RECYCLED WATER ADVISORY SIGNS SHALL BE PER SBWR STANDARD DETAILS AND SHALL BE POSTED PER LOCATIONS SHOWN ON IRRIGATION PLANS.
- 19. INSTALLATION OF DIRECT INJECTION SYSTEMS ON THE RECYCLED WATER IRRIGATION SYSTEM IS NOT
- 20. NO DRINKING FOUNTAINS OR EATING AREAS ARE ALLOWED IN THE APPROVED RECYCLED WATER USE AREA
- 21. ALL RECYCLED WATER METERS WILL BE SET BY THE LOCAL WATER UTILITY AFTER: A. THE SITE'S OWNER, DEVELOPER, OR CONTRACTOR HAS APPLIED FOR RECYCLED WATER SERVICE WITH THE LOCAL WATER UTILITY, THE WATER SERVICE AGREEMENT HAS BEEN APPROVED, AND ALL APPLICABLE FEES HAVE BEEN PAID
- B. THE WATER UTILITY HAS RECEIVED AUTHORIZATION FROM SBWR TO SET RECYCLED WATER METERS. 22. NO OVERSPRAY OR RUNOFF OF RECYCLED WATER IS ALLOWED ON ANY NON-APPROVED USE AREA. PONDING OF RECYCLED WATER DUE TO IRRIGATION IS NOT ALLOWED IN ANY AREA. UPON RECEIVING RECYCLED WATER, THE ON-SITE RECYCLED WATER IRRIGATION SYSTEM MUST PASS A COVERAGE TEST PERFORMED BY SBWR
- 23. CONTRACTOR SHALL SUBMIT AS-BUILT IRRIGATION PLANS TO SBWR.

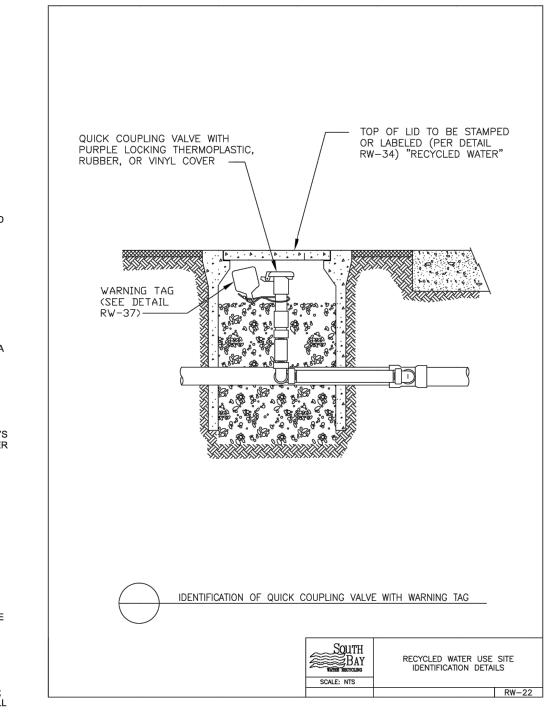

TOP OF LID TO BE STAMPED

RW-34) "RECYCLED WATER"


. WARNING TAG


RECYCLED WATER USE SITE IDENTIFICATION DETAILS


(SEE DETAIL RW-37)


OR LABELED (PER DETAIL


IDENTIFICATION OF ISOLATION GATE VALVE (3" OR SMALLER) WITH WARNING TAG

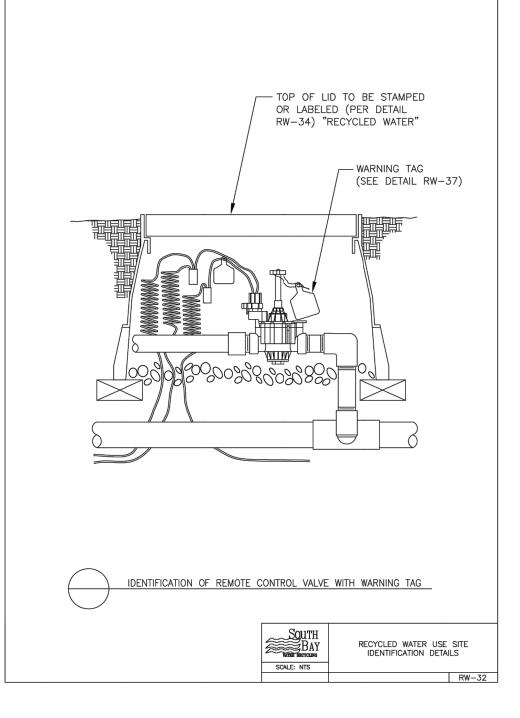

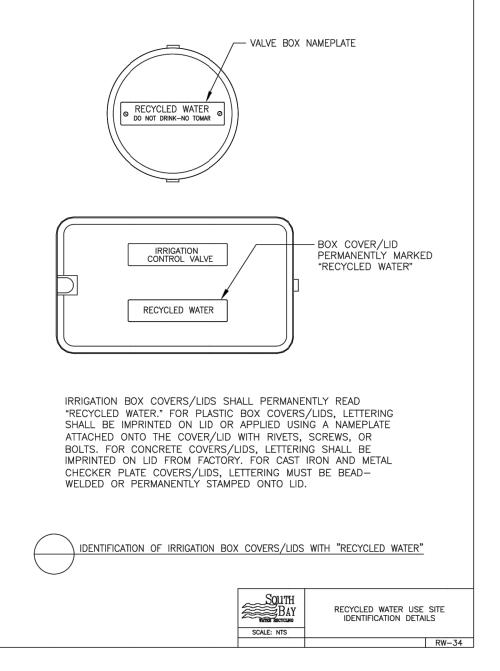

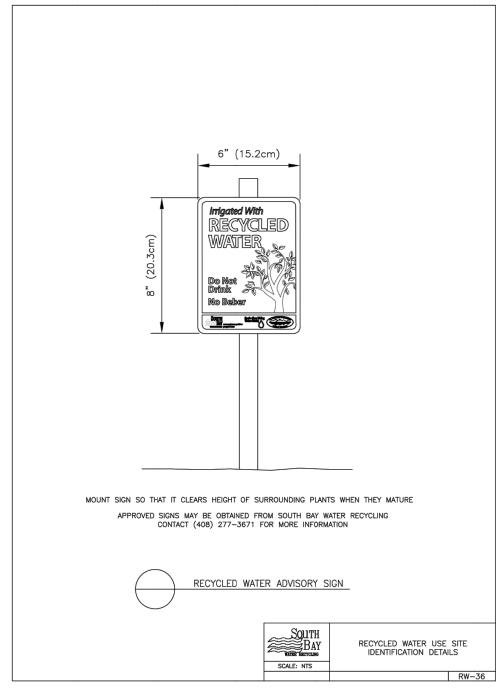

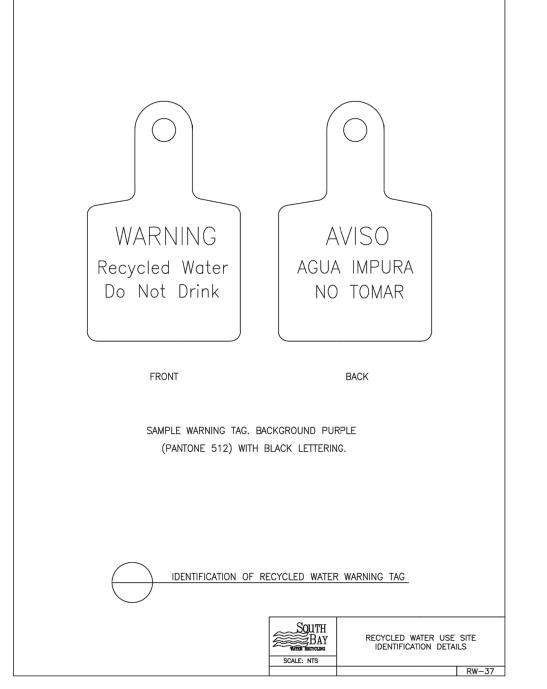

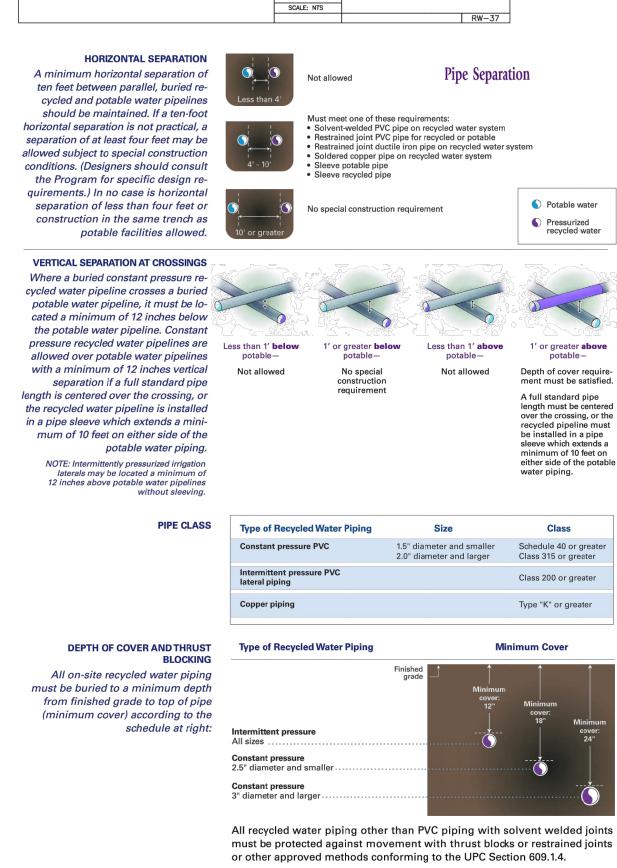

Detail RW-RNR1



Project Title

Key Plan

B 02_25_26 - RIDDER PARK NORTH & SOUTH BUILDING **BACK UP GENERATOR BID SET**

1290 RIDDER PARK DR., SAN JOSE CA 95131

SANTA CLARA COUNTY OFFICE OF EDUCATION

No.	Description	Date
1	BID SET	09.05.25

Drawing Title

SOUTH BAY RECYCLED WATER IRRIGATION NOTES AND DETAILS

Architect Seal


File Number Drawing No **Application Number** 09. 05. 2025

Project No. 06401

ANLA: 2210

DDW ACCEPTANCE SIGNATURES FOR SBWR PROJECT ID SJW5072AP2

SBWR - SOUTH BAY WATER RECYCLING DATE:

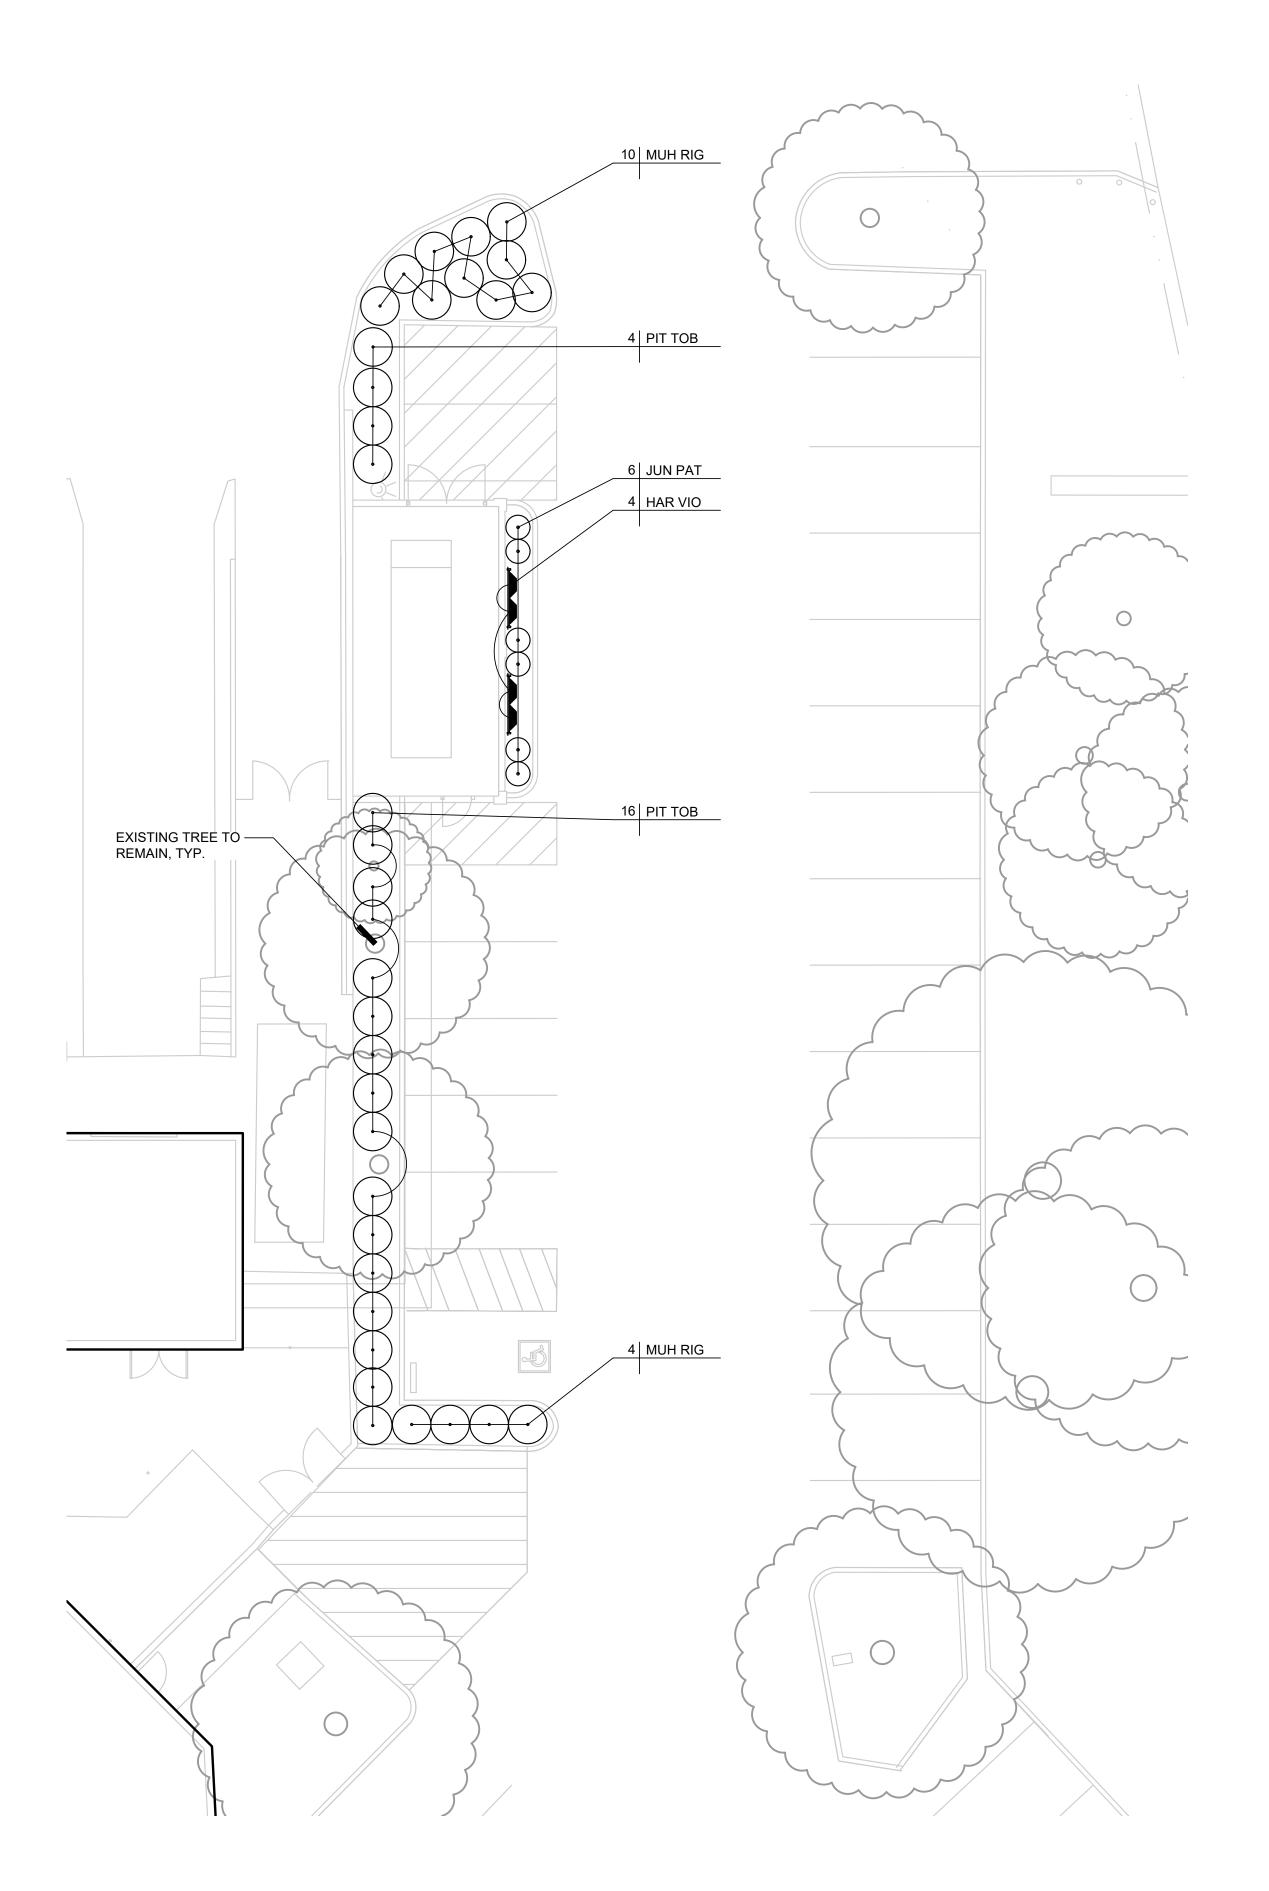

PLANTING NOTES

- 1. THESE NOTES ARE FOR GENERAL REFERENCE IN CONJUNCTION WITH, AND AS A SUPPLEMENT TO THE WRITTEN SPECIFICATIONS, DETAILS, ADDENDA AND CHANGE ORDERS ASSOCIATED WITH THE CONTRACT DOCUMENTS.
- 2. CONTRACTOR SHALL COORDINATE ALL WORK WITH OTHER TRADES PRIOR TO INSTALLATION.
- 3. CONTRACTOR SHALL BECOME FAMILIAR WITH THE LOCATION OF ALL EXISTING AND PROPOSED UNDERGROUND SERVICES AND IMPROVEMENTS WHICH MAY CONFLICT WITH WORK TO BE DONE. CONTACT UNDERGROUND SERVICE ALERT (USA) AT (800) 642-2444 PRIOR TO DIGGING. NOTIFY OWNER IMMEDIATELY SHOULD CONFLICTS ARISE.
- 4. FINE GRADING, HEADERS AND IRRIGATION COVERAGE SHALL BE APPROVED BY THE OWNER'S REPRESENTATIVE PRIOR TO PLANTING OPERATIONS.
- 5. CONTRACTOR SHALL LAY OUT PLANT MATERIAL PER PLAN AND FACE TO GIVE BEST APPEARANCE OR RELATION TO ADJACENT PLANTS, STRUCTURES OR VIEWS. CONTRACTOR TO OBTAIN APPROVAL FROM OWNER'S REPRESENTATIVE PRIOR TO INSTALLATION.
- 6. PLANT MATERIAL SHALL NOT BE INSTALLED IN AN AREA WHICH WILL CAUSE HARM TO ADJACENT STRUCTURES OR OBSTRUCT IRRIGATION SPRAY PATTERN. NOTIFY THE OWNER'S REPRESENTATIVE SHOULD CONFLICTS ARISE.
- 7. PLANT LOCATIONS ARE DIAGRAMMATIC AND MAY BE ADJUSTED IN THE FIELD AT THE OWNER'S REPRESENTATIVE REQUEST PRIOR TO INSTALLATION. OBTAIN APPROVAL OF PLANT LAYOUT FROM THE OWNER'S REPRESENTATIVE PRIOR TO PLANTING.
- 8. UNLESS OTHERWISE NOTED, FINISH GRADE OF SHRUB AND GROUND COVER AREAS SHALL BE 2" BELOW ADJACENT PAVING. TAPER 3" DEPTH BARK MULCH TOP DRESSING TO 1/2" BELOW ADJACENT PAVING (1-1/2" DEPTH) WITHIN 2' OF PAVING. FINISH GRADE OF SEEDED TURF AREAS SHALL BE 1/2" BELOW ADJACENT PAVING. FINISH GRADE OF SODDED TURF AREAS SHALL BE 1" BELOW ADJACENT PAVING.
- 9. PLANTING AREAS SHALL RECEIVE A 3" MIN. DEPTH BARK MULCH TOP DRESSING, UNLESS OTHERWISE NOTED. IN NON-BIORETENTION AREAS BARK MULCH SHALL BE REPUBLIC SERVICES PRO-CHIP MULCH, IN BIORETENTION AREAS BARK MULCH SHALL BE SHREDDED CEDAR BARK MULCH FROM PACIFIC LANDSCAPE SUPPLY (209) 593-1199, WWW.PACIFICLANDSCAPESUPPLY.COM, OR EQUAL.
- 10. NEWLY PLANTED MATERIAL SHALL BE THOROUGHLY SOAKED WITH WATER WITHIN 3 HOURS OF PLANTING.
- 11. EXISTING TREES, SHRUBS AND GROUND COVERS TO REMAIN SHALL BE PROTECTED. ANY DAMAGE CAUSED BY CONTRACTOR'S WORK OR NEGLIGENCE SHALL BE REPLACED OR REPAIRED AT THE CONTRACTOR'S EXPENSE TO THE SATISFACTION OF THE OWNER.
- 12. THIRTY DAYS AFTER PLANTING, CONTRACTOR SHALL RE-STAKE AND STRAIGHTEN TREES AS NECESSARY.
- 13. CONTRACTOR TO COLLECT AND SUBMIT SOIL SAMPLE TO WAYPOINT ANALYTICAL FOR SOIL AMENDING AND PREPARATION RECOMMENDATION PER SPECIFICATION SECTION 32 90 00.
- 14. CONTRACTOR SHALL COORDINATE ROUGH GRADING AND FINE GRADING TO ENSURE EXISTING SUITABLE TOPSOIL IS REMOVED, STOCKPILED AND REINSTALLED INTO PROPOSED LANDSCAPE AREAS PER LANDSCAPE SPECIFICATION SECTION 32 90 00. IN THE EVENT THERE IS NOT ENOUGH EXISTING TOPSOIL, OR NO PLACE TO STOCKPILE TOPSOIL, CONTRACTOR SHALL IMPORT AND INSTALL TOPSOIL PER LANDSCAPE SPECIFICATION SECTION 32 90 00.
- 15. THE CONTRACTOR SHALL BE RESPONSIBLE UNDER THIS CONTRACT FOR REPAIRING OR REPLACING, AT HIS OWN EXPENSE, SURFACE AND SUBSURFACE SITE FEATURES TO REMAIN, INCLUDING BUT NOT LIMITED TO STRUCTURES, FENCES, WALLS, PAVING SURFACES, PLANT MATERIAL AND/OR TREES DAMAGED OR DESTROYED, BOTH ON THIS PROPERTY OR THOSE PROPERTIES ADJACENT TO THIS SITE. Key Plan THE DAMAGED ITEM(S) WILL BE RESTORED TO THEIR ORIGINAL CONDITION OR REPLACED TO THE SATISFACTION OF THE OWNER'S REPRESENTATIVE.
- 16. REFER TO PLANTING DETAILS THIS SHEET AND SPECIFICATIONS SECTIONS:

329000

TEMPORARY TREE AND PLANT PROTECTION 015639

PLANT LEGEND

SYMBOL	SIZE	BOTANICAL NAME	COMMON NAME	WATER NEEDS*
TREES GIN BIL SHRUBS:	24" BOX	GINKGO BILOBA 'PRINCETON SENTRY'	PRINCETON SENTRY GINKGO	MODERATE
JUN PAT	5 GAL	JUNCUS PATENS	CALIFORNIA GREY RUSH	LOW
MUH RIG	5 GAL	MUHLENBERGIA RIGENS	DEER GRASS	LOW
PIT TOB	5 GAL	PITTOSPORUM TOBIRA ' VARIEGATA'	VARIEGATED MOCK ORANGE	MOD
VINES:				-
HAR VIO	5 GAL	HARDENBERGIA VIOLACEA	PURPLE VINE LILAC	MOD

*WATER NEEDS BASED ON: "WATER USE CLASSIFICATION OF LANDSCAPE SPECIES", ZONE 1, UNIVERSITY OF CALIFORNIA COOPERATIVE EXTENSION AND THE DEPARTMENT OF WATER RESOURCES, 2014.



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Consultant



T. 408.292.2196

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Project Title

B 02_25_26 - RIDDER PARK NORTH & SOUTH BUILDING **BACK UP GENERATOR BID SET**

1290 RIDDER PARK DR., SAN JOSE CA 95131

SANTA CLARA COUNTY OFFICE OF EDUCATION

No.	Description	Date
1	BID SET	09.05.25

PLANTING PLAN

Architect Seal

File Number **Application Number**


Project No. 06401

ANLA: 2210

L2.1 09. 05. 2025

Drawing No

SCALE: 1" = 10'-0"

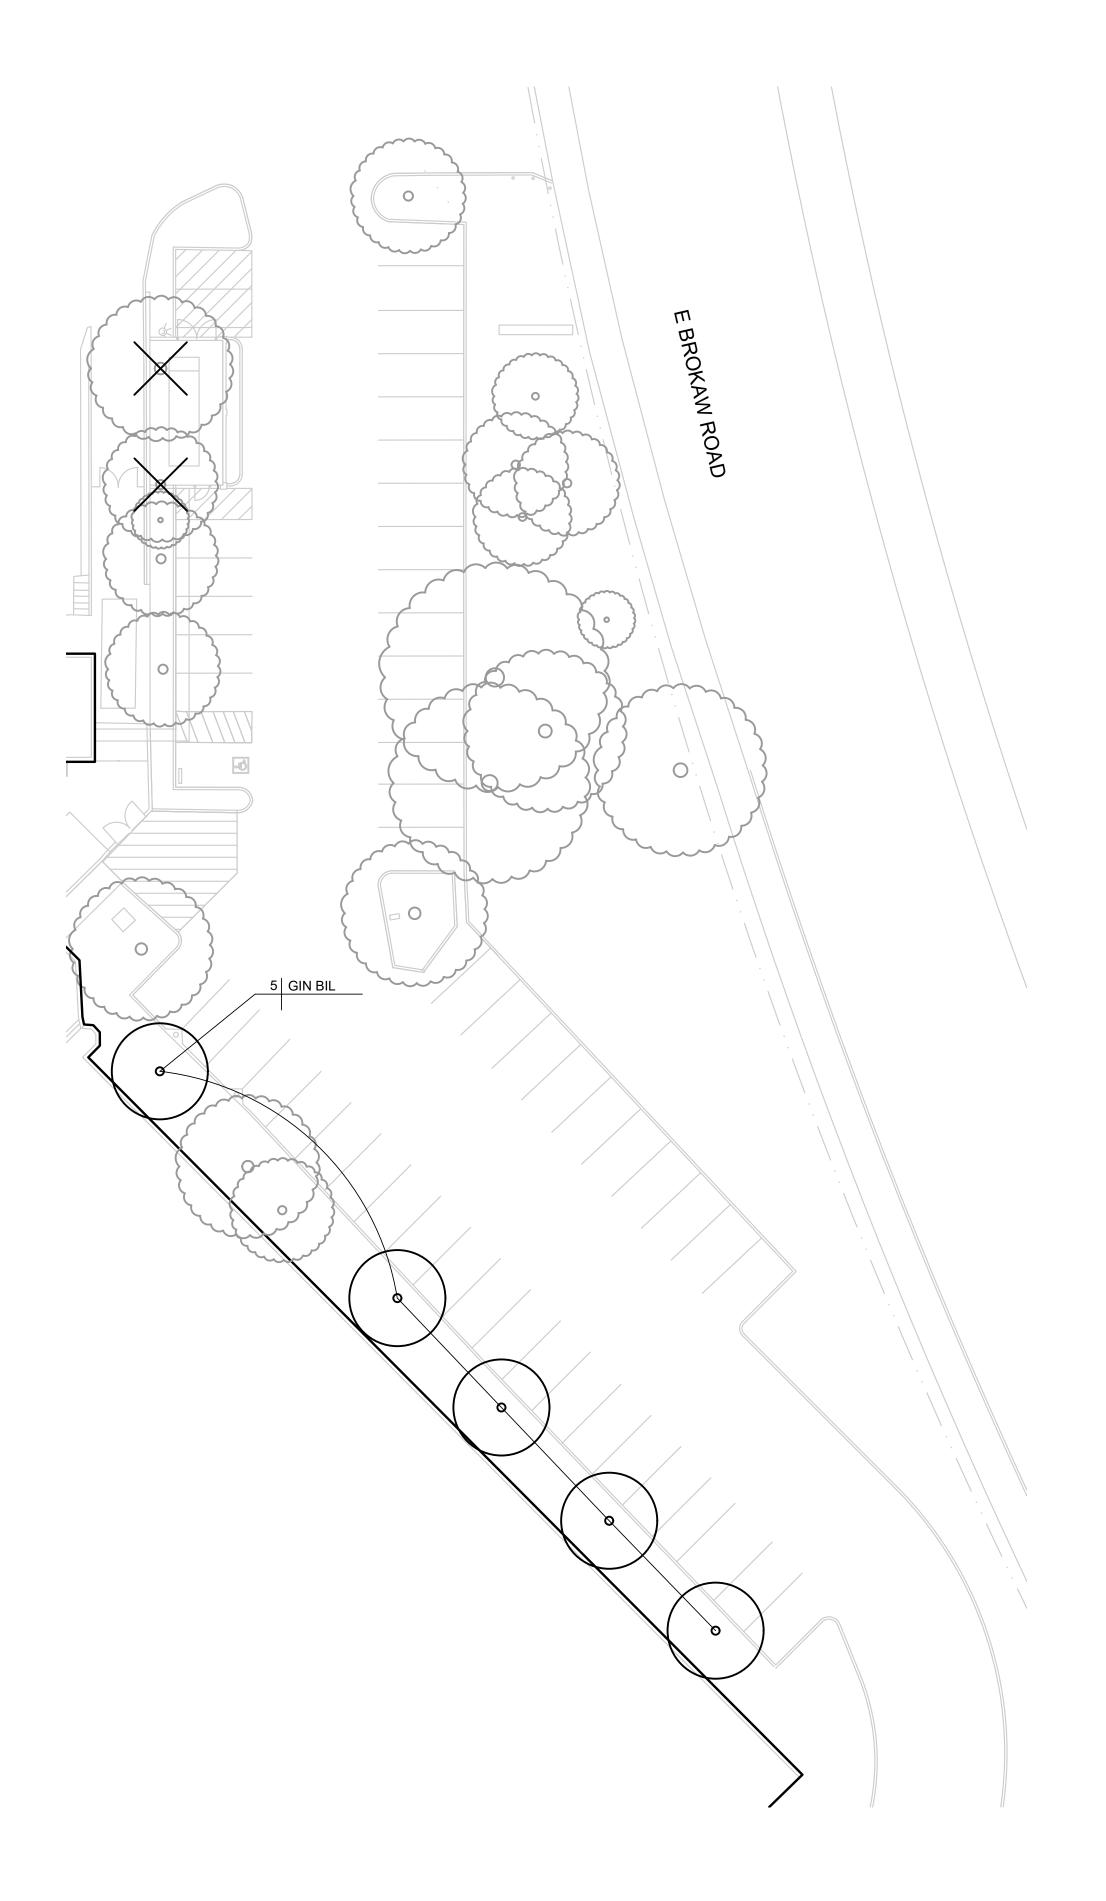

TREE MITIGATION LEGEND

BOTANICAL NAME COMMON NAME WATER* PRINCETON SENTRY GINKGO GINKGO BILOBA 'PRINCETON SENTRY' MODERATE

EXISTING TREES TO REMAIN, PROTECT IN PLACE



EXISTING TREE TO BE REMOVED, REMOVE STUMP AND ROOTS, TYP.

*WATER NEEDS BASED ON: "WATER USE CLASSIFICATION OF LANDSCAPE SPECIES", ZONE 1, UNIVERSITY OF CALIFORNIA COOPERATIVE EXTENSION AND THE DEPARTMENT OF WATER RESOURCES, 2014.

TREE MITIGATION NOTES

- 1. PROPOSED REMOVAL OF (2) NON-ORDINANCE TREES.
- 2. CIRCUMFERENCE OF EACH TREE TO BE REMOVED IS LESS THAN 38".
- 3. MITIGATION TREE QUANTITIES: (4) 15 GALLON TREES OR (2) 24" BOX TREES REQUIRED. (5) 24" BOX TREES PROPOSED.
- 4. NEW TREE PLANTING TO RECEIVE IRRIGATION FROM EXISTING IRRIGATION SYSTEM IN ITS RESPECTIVE PLANTER. ADJUST OR ADD SPRAY HEADS AS NECESSARY TO ACHIEVE 100% COVERAGE.
- 5. REFER TO TREE PRESERVATION DETAIL A, L2.3

TREE REMOVAL NOTES

- 1. THE LIMITS AND SCOPE OF DEMOLITION SHOWN HEREON ARE TO PROVIDE THE CONTRACTOR WITH A GENERAL SCOPE OF TREE REMOVAL WORK. PRECISE LIMITS OF PAVEMENT REMOVAL AND GRADING SHOULD BE TAKEN FROM THE CIVIL GRADING AND DRAINAGE PLAN. THE CONTRACTOR SHOULD ALSO REFERENCE THE ARCHITECTURAL PLANS AND OTHER LANDSCAPE
 ARCHITECTURAL PLANS AND THE CONSTRUCTION DOCUMENTS FOR A COMPLETE SCOPE OF WORK. VERIFY ALL DEMOLITION WITH THE OWNER'S REPRESENTATIVE
- 2. DEMOLITION WORK SHALL CONFORM TO CAL GREEN CODE SECTION 5.408.3 (CONSTRUCTION WASTE REDUCTION BY AT LEAST 50%)
 AND 5.408.4 (EXCAVATED SOIL AND LAND CLEARING DEBRIS), AND LOCAL CONSTRUCTION WASTE MANAGEMENT REQUIREMENTS. THE MOST STRINGENT CODE SHALL PREVAIL.
- 3. REFER TO PLANTING NOTES AND LEGEND, SHEET L2.1



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Consultant





Renewal Date

05.28.2025

Date

Key Plan

Project Title

B 02_25_26 - RIDDER PARK NORTH & SOUTH BUILDING **BACK UP GENERATOR BID SET**

1290 RIDDER PARK DR., SAN JOSE CA 95131

SANTA CLARA COUNTY OFFICE OF EDUCATION

No.	Description	Date
1	BID SET	09.05.25

TREE MITIGATION PLAN

Architect Seal

09. 05. 2025


ANLA: 2210

File Number Application Number

L2.2

Drawing No

SCALE: 1" = 20'-0" Project No. 06401

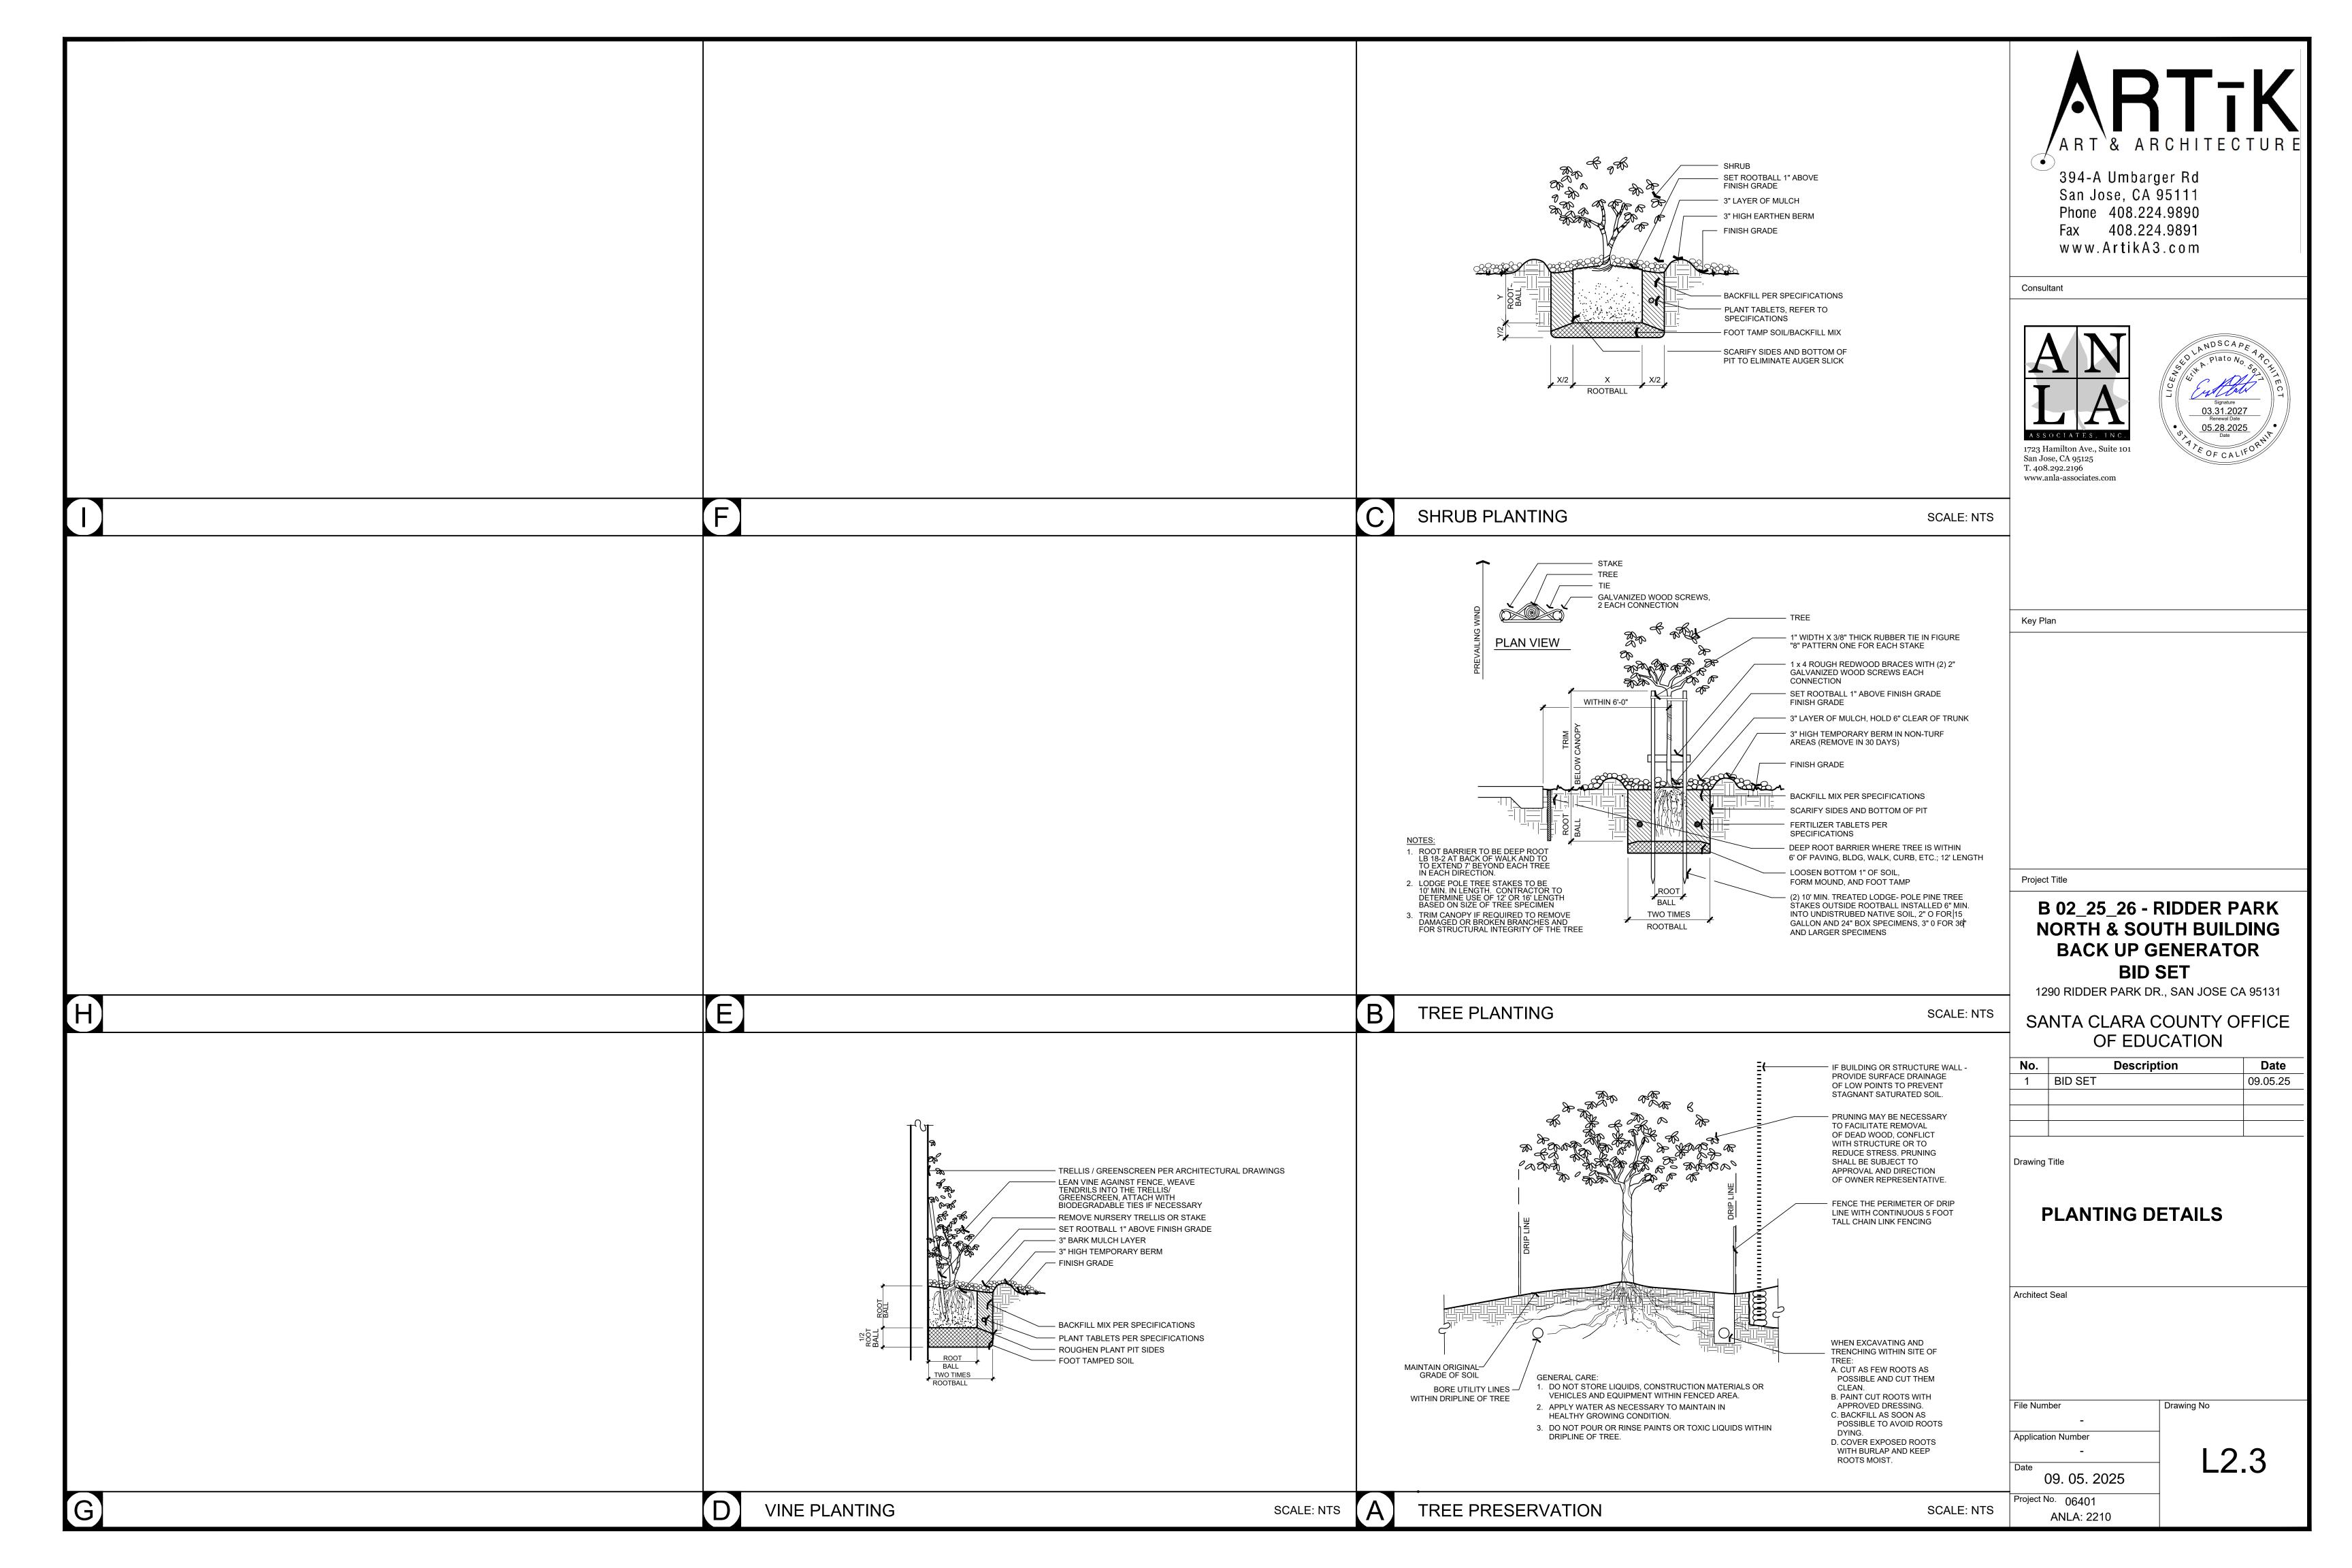

GENERAL NOTES

- 1. THE COMPLETE ELECTRICAL INSTALLATION SHALL BE IN ACCORDANCE WITH THE 2022 CBC (CALIFORNIA BUILDING CODE), 2019 CEC (CALIFORNIA ELECTRICAL CODE), 2019 CALIFORNIA BUILDING ENERGY EFFICIENCY STANDARDS AND SAN JOSE CITY REQUIREMENTS, THE LATEST RULES AND REGULATIONS OF THE SAFETY ORDER ISSUED BY THE DIVISION OF INDUSTRIAL SAFETY, THE NATIONAL BOARD OF FIRE UNDERWRITERS, ALL APPLICABLE STATE AND LOCAL CODES ISSUED BY AUTHORITIES HAVING JURISDICTION.
- 2. THE CONTRACTOR, PRIOR TO BIDDING, SHALL VISIT THE JOB SITE TO BECOME ACQUAINTED WITH THE EXISTING INSTALLATION AND SYSTEMS RELATED TO HIS WORK AND SHALL INCLUDE IN THE BID PROPOSAL ALL LABOR AND MATERIALS REQUIRED FOR THE ELECTRICAL INSTALLATION TO BE COMPLETE AND OPERATIVE.
- 3. THE CONTRACTOR SHALL COORDINATE ALL WORK WITH THE ENGINEER, THE SCCOE AND WITH OTHER WORK TO BE PROVIDED.
- 4. THE CONTRACTOR SHALL ORGANIZE AND CONDUCT HIS WORK TO MINIMIZE PLANT SHUTDOWN TIME. COORDINATE ALL POWER SHUTDOWNS WITH THE OWNER'S REPRESENTATIVE.
- 5. PROVIDE SUBMITTALS FOR ALL (N) ELECTRICAL EQUIPMENT FOR APPROVAL BEFORE ORDERING AND INSTALLATION.
- 6. SUBMIT COPIES OF PANEL SCHEDULES WHERE REQUIRED FOR APPROVAL.
- 7. EXISTING UTILITY LOCATIONS ARE APPROXIMATE ONLY.
- 8. ALL EXISTING EQUIPMENT SHALL REMAIN IN PLACE UNLESS OTHERWISE NOTED.
- 9. LOCATIONS OF CONTROLLERS, CONDUIT, PULL BOXES AND OTHER EQUIPMENT AS SHOWN ON THE PLANS ARE APPROXIMATE AND MAY BE CHANGED TO SUIT FIELD CONDITIONS AS DIRECTED BY THE ENGINEER.
- 10. ALL EXTERIOR MOUNTED EQUIPMENT SHALL BE WEATHERPROOF.
- 11. UNLESS OTHERWISE INDICATED, THE MINIMUM SIZE OF CONDUCTORS SHALL BE #12 AWG THW, THWN OR XHHW STRANDED COPPER ONLY.
- 12. GREEN INSULATED GROUND CONDUCTORS SHALL BE INSTALLED IN ALL FEEDER AND BRANCH CIRCUIT CONDUITS.
- 13. ELECTRICAL EQUIPMENT AND FEEDERS SHALL BE SUPPORTED AND/OR ANCHORED IN ACCORDANCE WITH CBC SEISMIC REQUIREMENTS.
- 14. PROVIDE LABELS ON ALL EQUIPMENT AND DEVICES. LABELS SHALL BE PHENOLIC TYPE WITH BLACK LETTERS ON WHITE BACKGROUND, ATTACHED TO THE EQUIPMENT WITH STAINLESS STEEL SCREWS.
- 15. SEAL OPENINGS AROUND NEW CONDUIT AND CONDUIT OPENINGS WHERE CONDUIT WAS REMOVED TO PREVENT PASSAGE OF WATER OR WATER AND
- 16. THE CONTRACTOR SHALL MAINTAIN AT THE JOB SITE, AN UP TO DATE "AS-BUILT" DRAWING SET. THE "AS-BUILT" DRAWING SET SHALL REFLECT ALL APPROVED CHANGES TO THE DESIGN DRAWINGS. THE "AS-BUILT" DRAWING SET SHALL BE KEPT CLEAN AND IN GOOD CONDITION AND SHALL BE TURNED OVER TO THE OWNER AT THE COMPLETION OF THE PROJECT.
- 17. UPON COMPLETION OF HIS WORK, THE CONTRACTOR SHALL SCHEDULE AND PERFORM A COMPLETE FUNCTIONAL TEST TO DEMONSTRATE TO THE OWNER THAT THE NEW INSTALLATION IS OPERATING AS INTENDED. ANY DEFECTS OR DEFICIENCIES IN THE MATERIALS OR WORK SHALL BE CORRECTED IMMEDIATELY BY AND AT THE CONTRACTOR'S EXPENSE.

ABBREVIATIONS

A AF	AMMETER, AMPERE, AMBER AMPERE FRAME	INST	INSTANTANEOUS
ANNUN AFC AFG AT	ANNUNCIATOR AVAILABLE FAULT CURRENT ABOVE FINAL GRADE AMPERE TRIP	KAIC KVA KW	THOUSAND AMPERE INTERRUPTING CAPACITY KILOVOLT AMPERE KILOWATT
ATS	AUTOMATIC TRANSFER SWITCH	LT FLEX LTG	LIQUID TIGHT FLEX CONDUIT LIGHTING
BKR	BREAKER	MSB	MAIN SWITCHBOARD
C CBC CKT	CONDUIT, CONTACTOR, CONTROL CALIFORNIA BUILDING CODE CIRCUIT	MT MTS	EMPTY MANUAL TRANSFER SWITCH
CP CT	CONTROL PANEL CURRENT TRANSFORMER	(N)	NEW
CU	COPPER	OFCI	OWNER-FURNISHED, CONTRACTOR INSTALLED
(E) ELEV EM EMS/BMS/BIM ERMS	EXISTING ELEVATOR EMERGENCY BUILDING ENERGY MANAGEMENT SYSTEM ENERGY REDUCTION MAINTENANCE SWITCH	PCGRS PNL PQM PV	PVC COATED GALVANIZED RIGID STEEL CONDUIT PANEL POWER QUALITY METER PHOTO VOLTAIC/SOLAR POWER
EV	ELECTRIC VEHICLE	RCPT	RECEPTACLE
FLA	FULL LOAD AMPS	SCCR SPD	SHORT CIRCUIT RATING SURGE PROTECTION DEVICE
G GEN	GREEN, GROUND, GENERATOR GENERATOR	ST	SHUNT TRIP
GFI GND GRS	GROUND FAULT GROUND GALVANIZED RIGID STEEL CONDUIT	TP TSP	TWISTED PAIR TWISTED SHIELDED PAIR
GIVO	GALVANIZED MIGID STELL CONDOTT	UON	UNLESS OTHERWISE NOTED

LEGEND

SHEET NOTE REFERENCE



4444

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20A, 125V DUPLEX RECEPTACLE, NEMA 5-20R, +18", UON. "ELB"-2 INDICATES PANEL "ELB" CKT 2. RED COLOR IF ON EMERGENCY CKT.

GROUND FAULT PROTECTED EXPLOSION PROOF CORROSION RESISTANT TWIST LOCK WEATHERPROOF

LIGHT SWITCH +45" U.O.N.

NEW ELECTRICAL EQUIPMENT

EXISTING ELECTRICAL EQUIPMENT

ELECTRICAL EQUIPMENT TO BE DISCONNECTED AND REMOVED

CONDUIT RUN UNDERGROUND OR BELOW FLOOR

CONDUIT RUN ABOVE GRADE OR ON CEILING

CONDUIT RUN WITH WIRES. () INDICATES GROUND, () INDICATES NEUTRAL,

(1) INDICATES HOT WIRES

FLEXIBLE METAL CONDUIT EXISTING PRE CAST CONCRETE PULL BOX

NEW PRE CAST CONCRETE PULLBOX COVER MARKED "ELECTRICAL"

SEE CALTRANS STANDARD PLAN ES-E8. MOTOR, SQUIRREL CAGE INDUCTION

NUMBER IF PRESENT INDICATES HORSEPOWER 400 CIRCUIT BREAKER, THERMAL MAGNETIC TRIP SHOWN, 3 POLE UNLESS INDICATED OTHERWISE.

SWITCH - CURRENT RATING INDICATED, 3 POLE 100

UNLESS INDICATED OTHERWISE.

FUSE - RATING INDICATED 225

SURGE ARRESTER TRANSFORMER, SECONDARY VOLTAGES, PHASE AND \times

RATING INDICATED AS APPLICABLE PUSH-BUTTON SWITCH, MOMENTARY CONTACT, NORMALLY OPEN

30 切 NON FUSED DISCONNECT SWITCH, SIZE INDICATED,

3 POLE UNLESS INDICATED OTHERWISE.

• OR GROUND ELECTRODE, 5/8"ø X 10'-0" COPPER CLAD STEEL

REMOVE AND BECOME PROPERTY OF CONTRACTOR

DRAWING INDEX

- E-1 ELECTRICAL GENERAL E-2EMERGENCY POWER SITE PLAN
- E-3ENLARGED PLAN - SOUTH BUILDING (BLDG #1) SERVICE
- ENLARGED PLAN NORTH BUILDING (BLDG #3) SERVICE E-4 E-5SINGLE LINE DIAGRAM - BLDG #1
- E-6 SINGLE LINE DIAGRAM - BLDG #3
- E-7GENERATOR DETAILS
- E-8 SWITCHBOARD DETAIL - BLDG #1 E-9SWITCHBOARD DETAIL - BLDG #3
- E 10PG&E SHORT CIRCUIT LETTERS


SCOPE OF WORK

NORTH BUILDING:

THE SCOPE OF WORK INCLUDES REMOVING THE EXISTING 300 KW GENERATOR THAT PROVIDES BACKUP TO ONLY DATA CENTER AND PROVIDING A NEW 500 KW GENERATOR THAT WILL PROVIDE BACKUP POWER TO THE ENTIRE BUILDING

SOUTH BUILDING:

THE SCOPE OF WORK INCLUDES PROVIDING A NEW 500 KW GENERATOR THAT WILL PROVIDE BACKUP POWER FOR THE ENTIRE BUILDING.

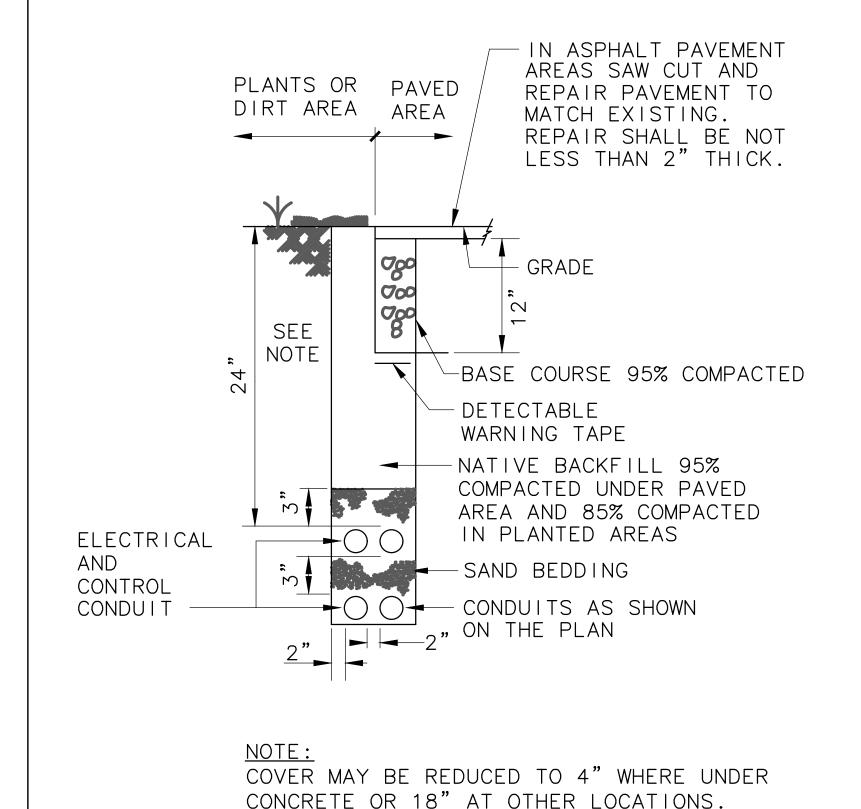


TRENCH DETAIL (TYP)

NO SCALE

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CONSULTANT LOGO

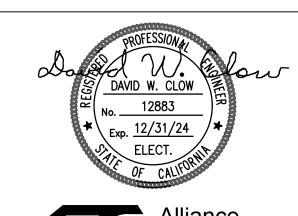


Engineering Consultants, Inc. 4701 Patrick Henry Drive, Bldg, 10 phone (408) 970-9888

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Santa Clara, CA 95054

PROJECT NO. 175-21-07

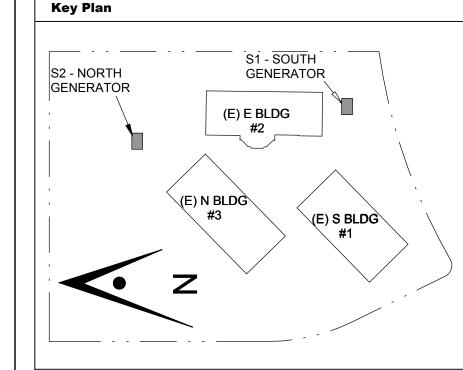

Project Title

B 02_25_26 - RIDDER PARK NORTH & SOUTH BUILDING BACK UP GENERATOR BID SET

1290 RIDDER PARK DR., SAN JOSE CA 95131

SANTA CLARA COUNTY OFFICE OF EDUCATION

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1	BID SET	09.05.25
	•	•

Drawing Title


ELECTRICAL GENERAL

Consultant Seal


Drawing No. 09. 05. 2025

Project Number

E-'

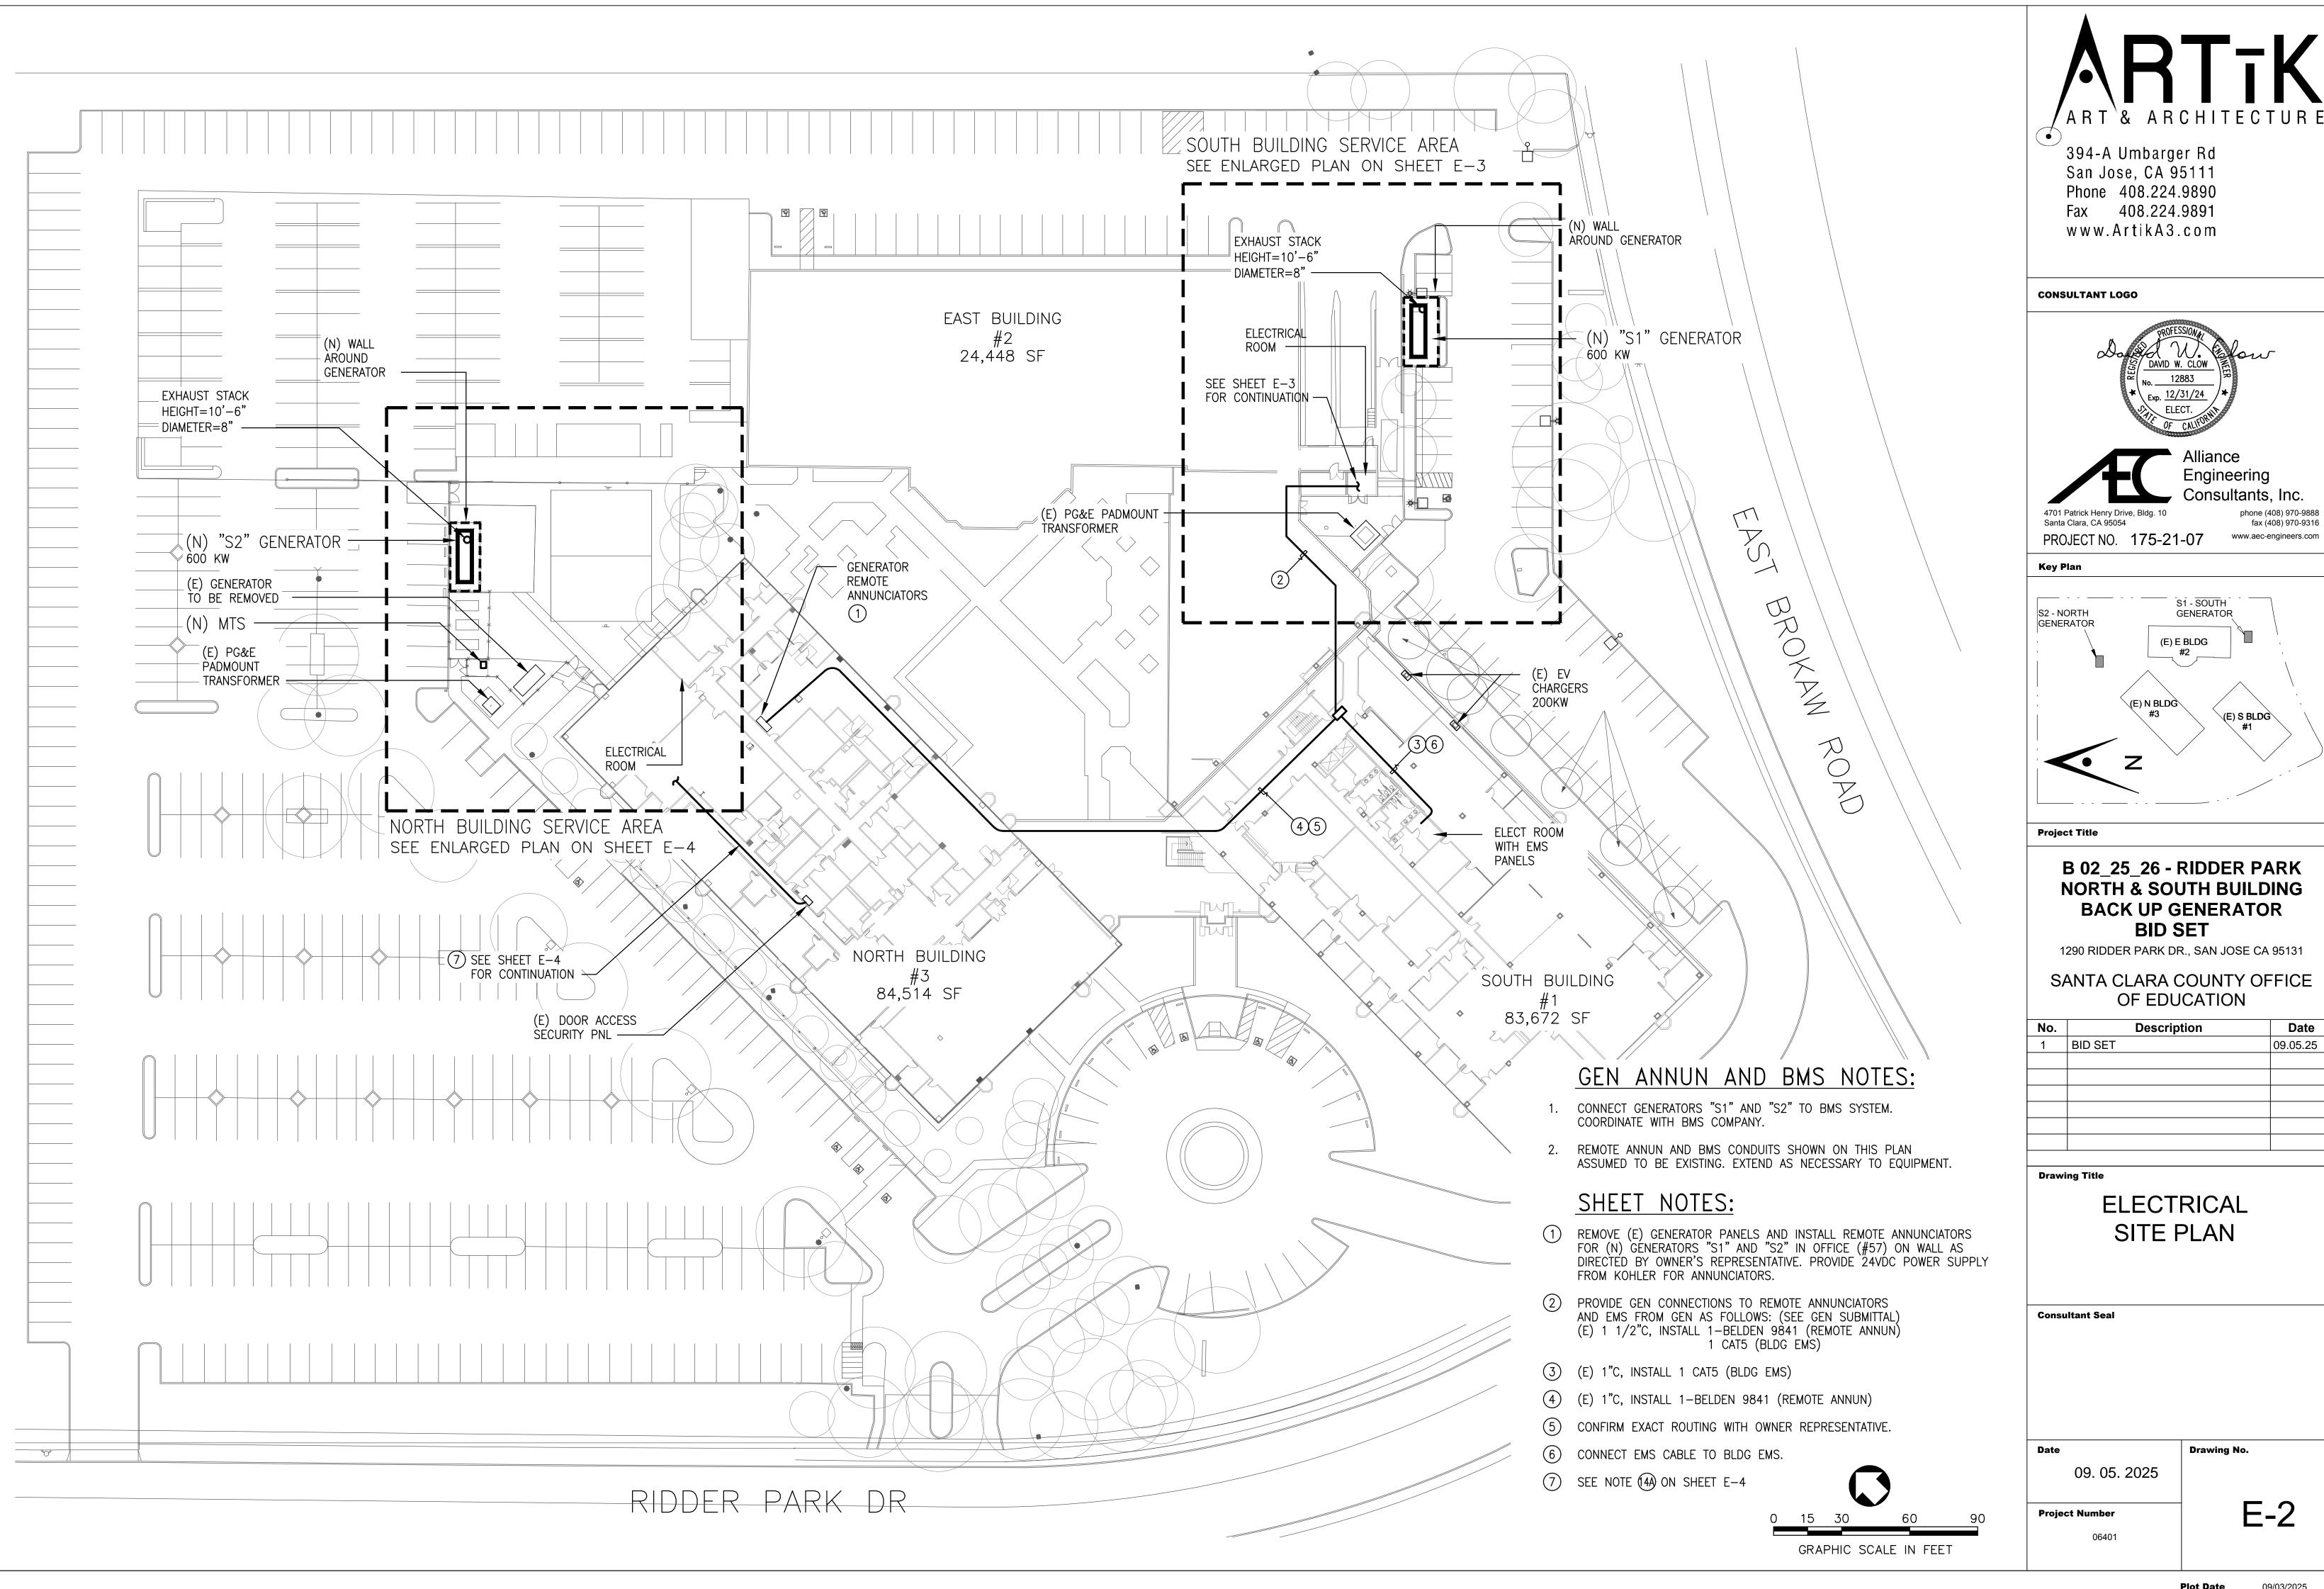

No.	Description	Date
1	BID SET	09.05.25

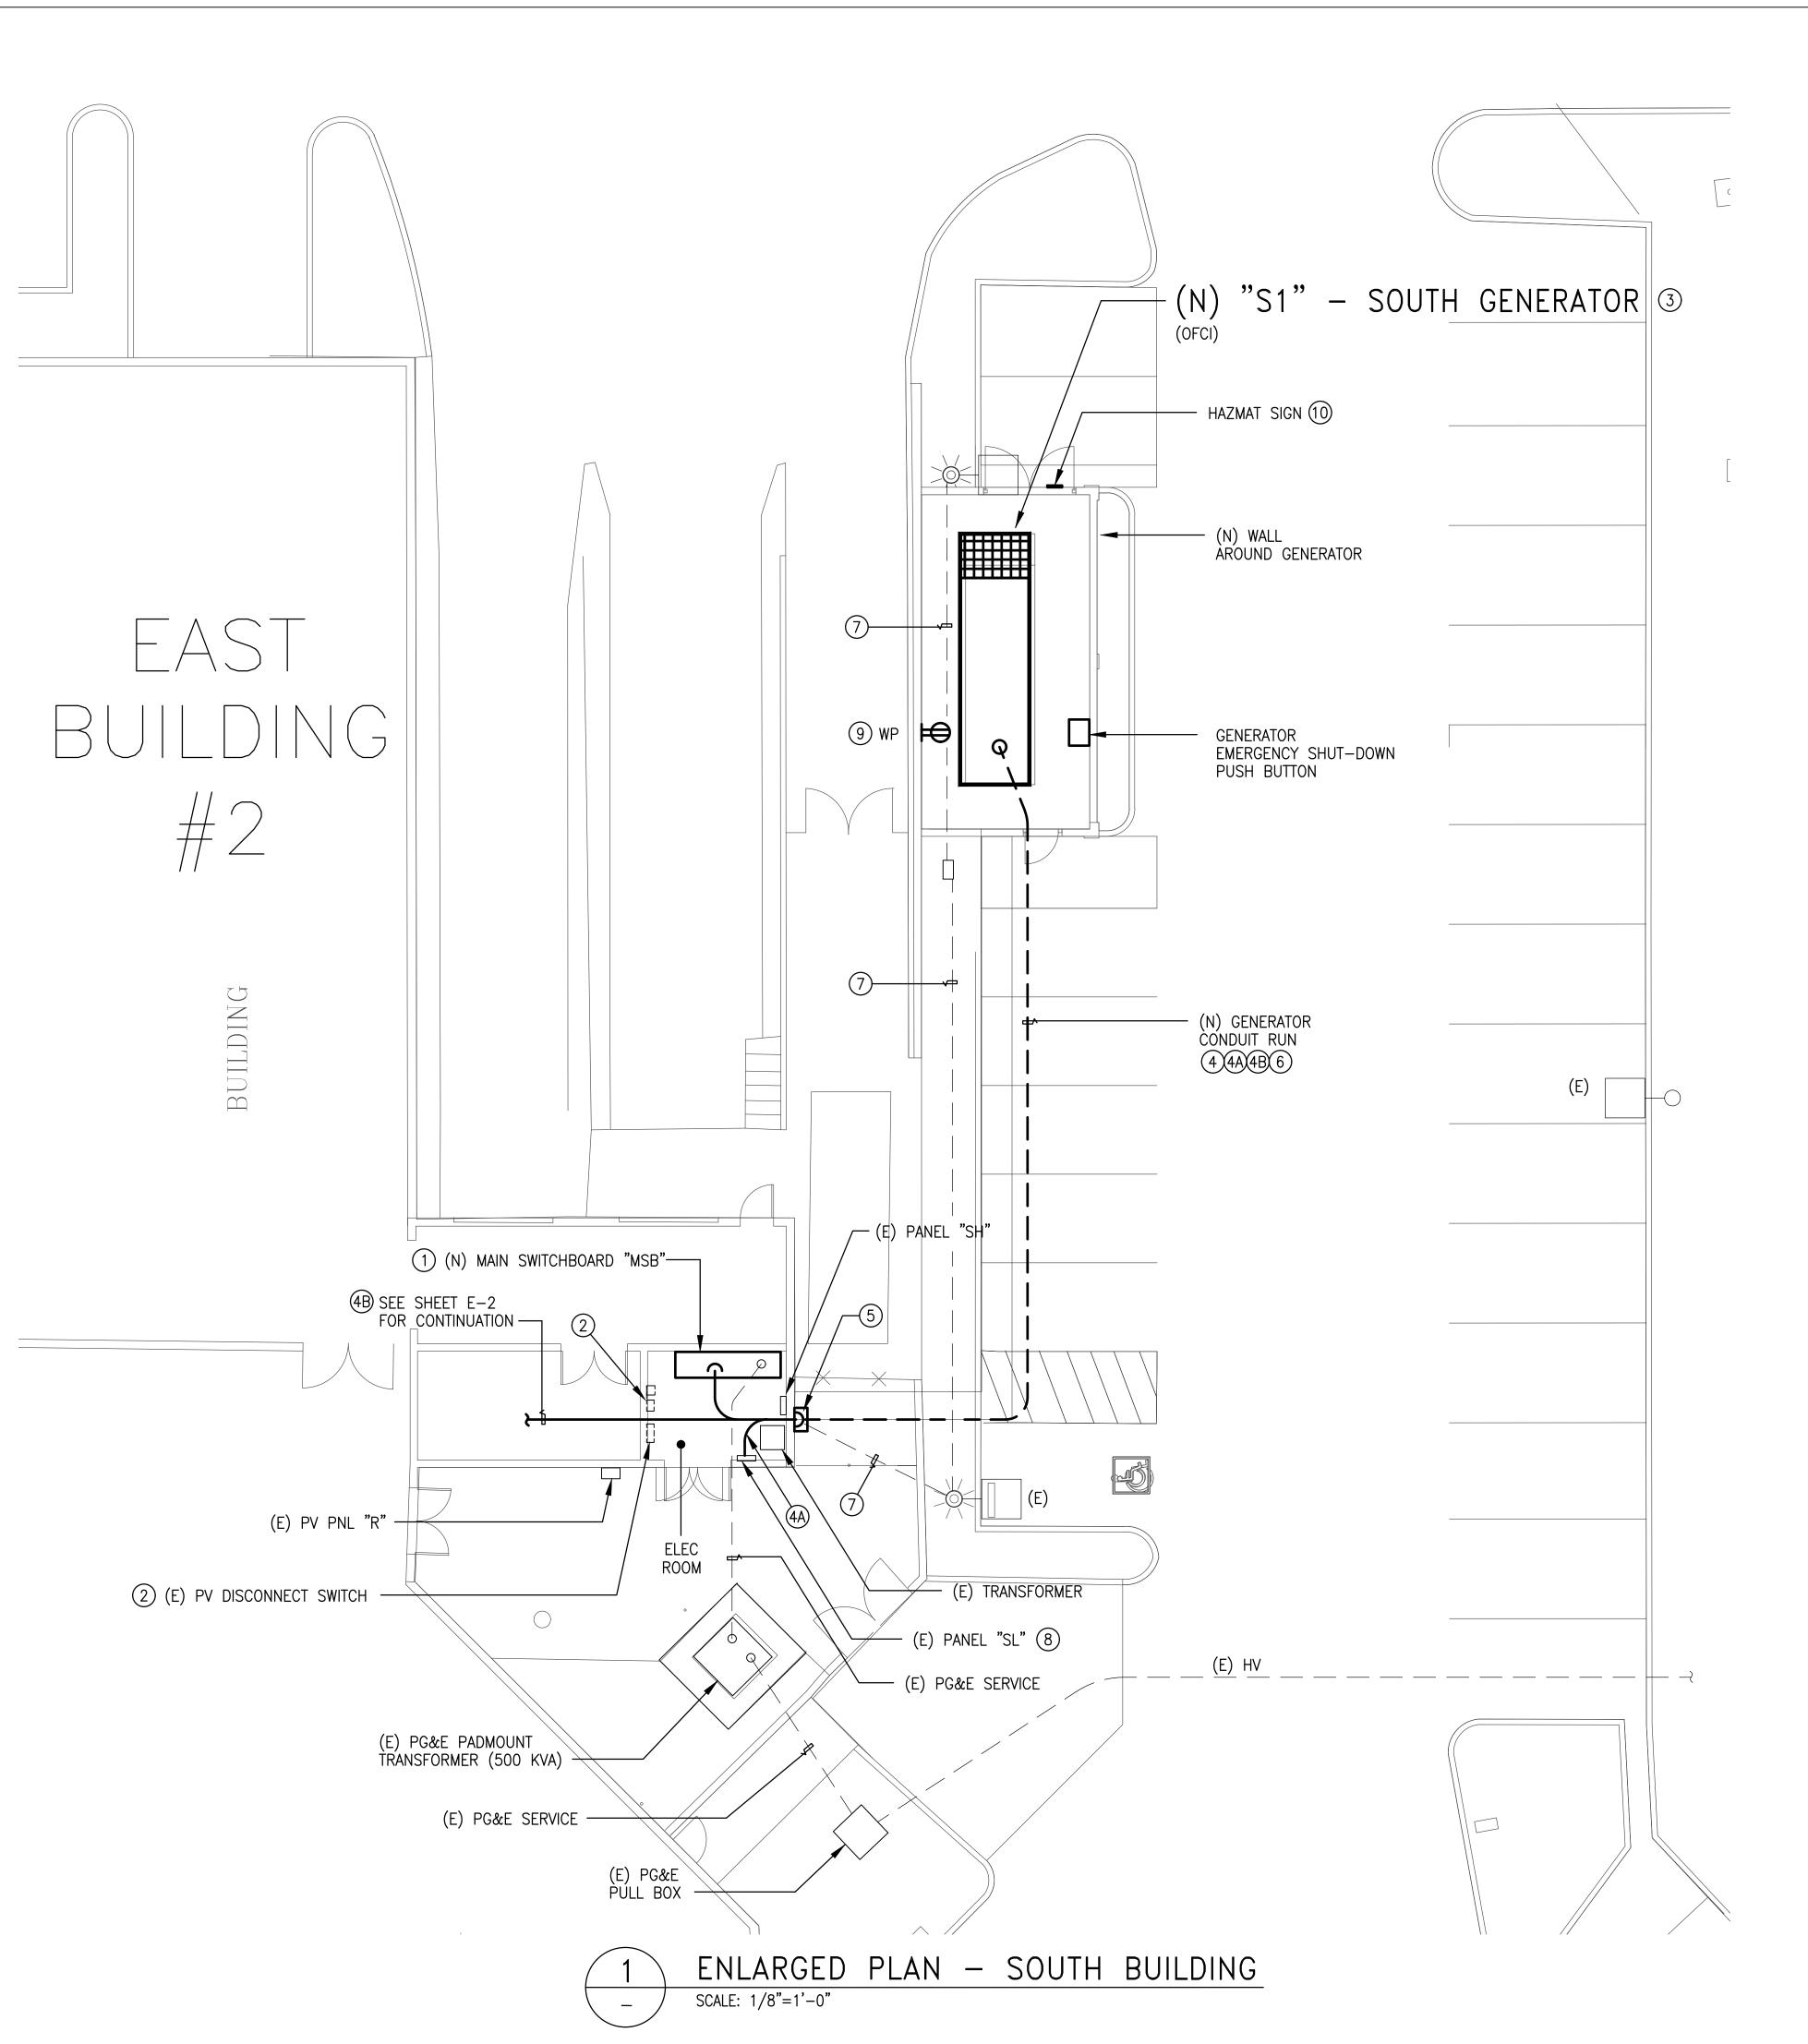


GENERAL NOTES:

- 1. ALL (E) ELECTRICAL EQUIPMENT SHALL REMAIN IN PLACE,
- 2. SEAL ALL CONDUIT OPENING AS SHOWN IN DETAILS ON SHEET E-8.
- 3. THE CONTRACTOR SHALL LOCATE EXISTING UTILITIES BEFORE

SHEET NOTES:


- a. COORDINATE A POWER SHUTDOWN WITH PG&E AND OWNER REPRESENTATIVE.
 - b. DISCONNECT THE (E) PG&E SERVICE CABLES AND ALL OTHER FEEDER CABLES FROM (E) MSB.
 - c. RC (E) IEM SWBD AND INSTALL A NEW SWBD IN THE. SAME LOCATION. SEE SHEET E-5 AND E-8 FOR WORK
 - d. RECONNECT ALL THE (E) CABLES TO (N) MSB.
- REMOVE (E) UN-USED EMPTY PANEL AND ADJUST a. SMALL PANEL LOCATIONS AS NEEDED TO MAKE SPACE FOR GENERATOR PROGRAMMED TRANSFER CONTROLS.
 - b. COORDINATE WITH PG&E TO RE-CONNECT THE ELECTRIC SERVICE.
- 3 INSTALL (N) 600 KW GENERATOR. SEE SHEET E-7 FOR DETAILS.
- 3-4"C WITH CONDUCTORS PER NOTE 4 ON SHEET E-5. 1-1/2"C, 2#10 (GEN START)
- 1-1/2"C, 3#4 (GEN PANEL) 1#8 (G)
- (4B) 1-1/2"C, 1 BELDEN 9841 (REMOTE ANNUN) 1 - CAT5 (BLDG EMS)
- (5) CONDUIT RISES ON OUTSIDE WALL, PENETRATES WALL AND RUNS IN CEILING SPACE. PROVIDE PULLBOX ON WALL FOR POWER CABLES IN NOTES (4) AND (4A) AND PULLBOX FOR LOW VOLTAGE, GEN START AND CABLES IN NOTE (4B).
- 6 INSTALL CONDUIT RUNS IN (E) 24" WIDE x 36" DEEP TRENCH.
- 7 MAINTAIN (E) PARKING LIGHT CONDUIT AND CONDUCTORS IN OPERATION DURING CONSTRUCTION. REPLACE IF DAMAGED DURING CONSTRUCTION.
- RC UNUSED CB'S AND INSTALL NEW 70A/2P FOR GEN ACCESSORIES PANEL.
- INSTALL WEATHERPROOF 125 V, 20A, NEMA 5-20R RECEPTACLE AND CONNECT TO 20A CKT BKR IN GEN PANEL WITH 3/4"C, 2#12 AND 1#12 (G).
- PROVIDE 16"x16" ALUMINUM HAZMAT SIGN. SEE ARCH

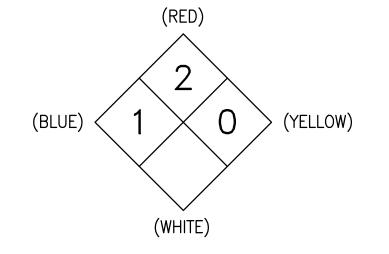



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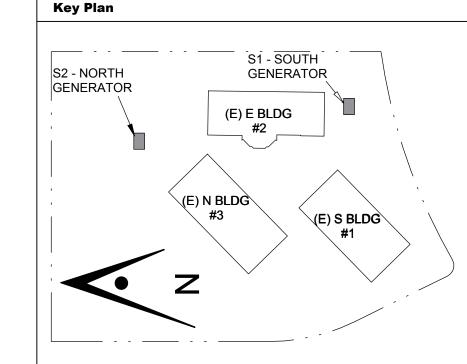
CONSULTANT LOGO

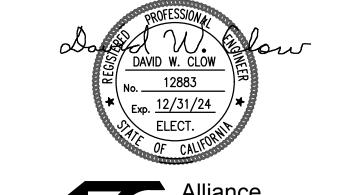

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PROJECT NO. 175-21-07



Project Title

B 02_25_26 - RIDDER PARK NORTH & SOUTH BUILDING BACK UP GENERATOR BID SET

1290 RIDDER PARK DR., SAN JOSE CA 95131

SANTA CLARA COUNTY OFFICE OF EDUCATION

No.	Description	Date
1	BID SET	09.05.25
		•

Drawing Title


ENLARGED PLAN -SOUTH BLDG #1 SERVICE

Consultant Seal

Drawing No. 09. 05. 2025

Project Number

GRAPHIC SCALE IN FEET

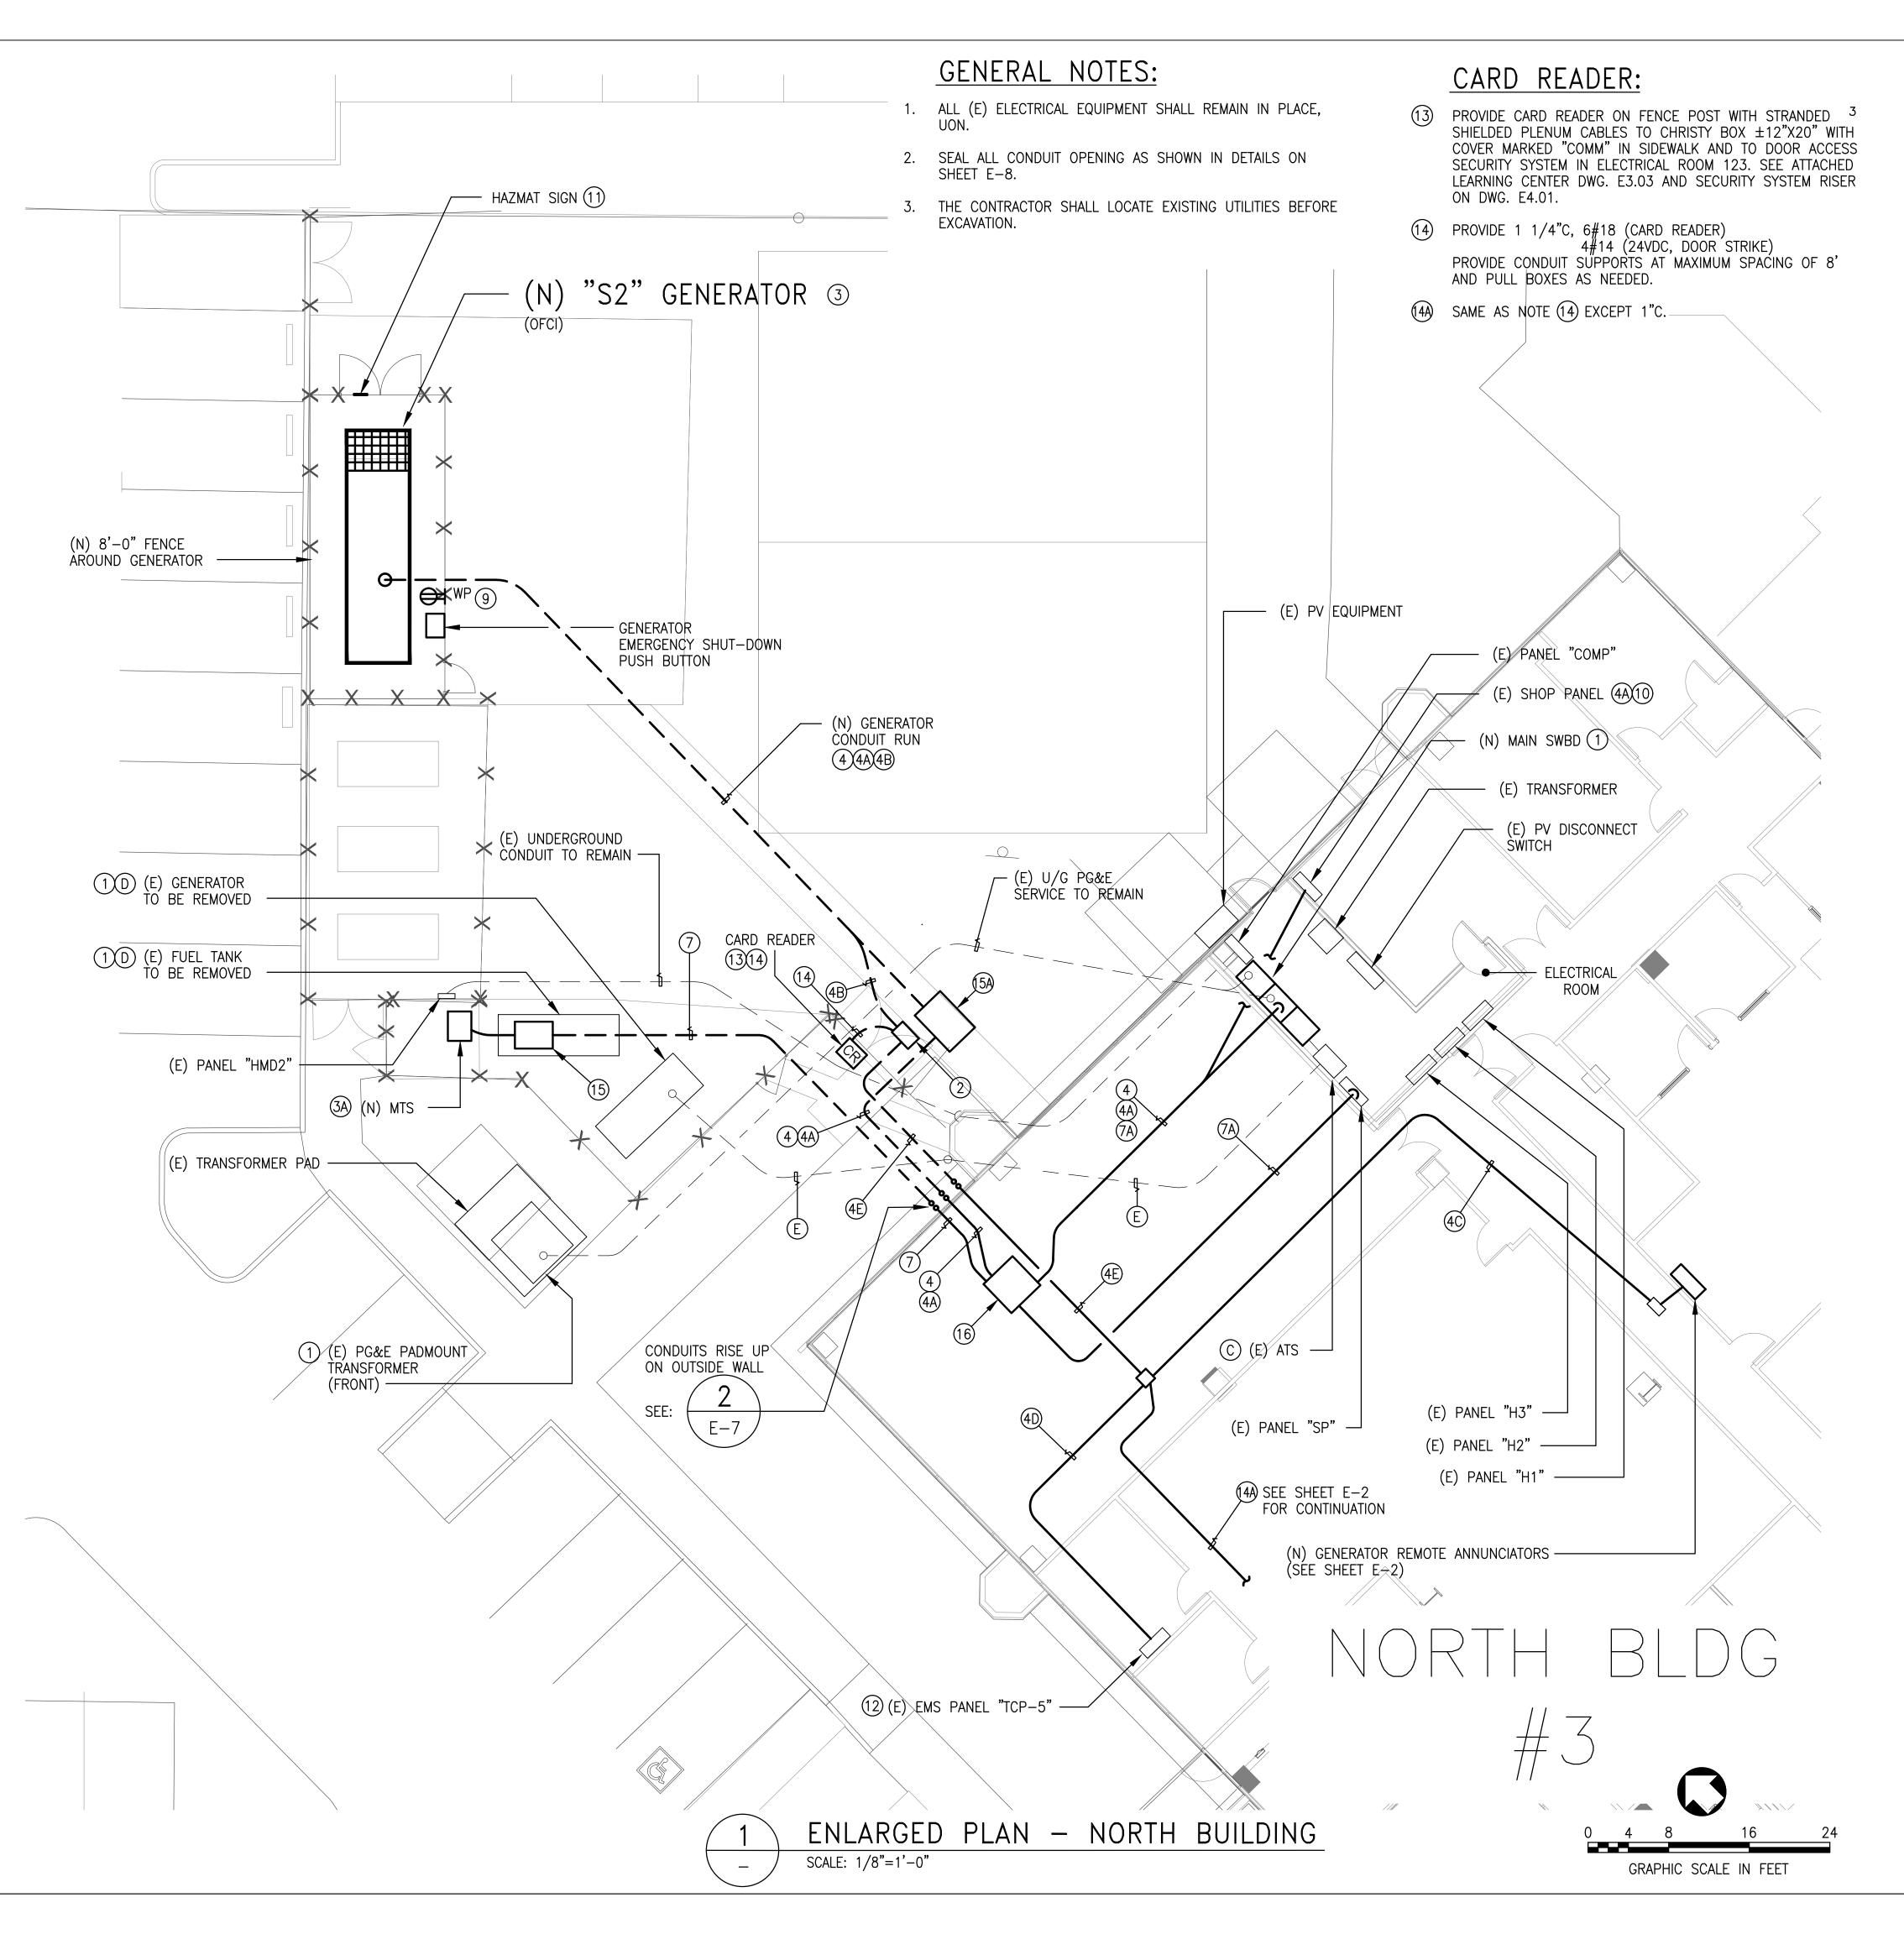

DEMOLITION NOTES:

- A NOT USED.
- B NOT USED.
- © RC (E) GENERAC 600A ATS AFTER THE (N) GENERATOR IS INSTALLED AND OPERATING.
- D RC (E) GENERATOR AND RC (E) FUEL TANK AFTER THE (N) GENERATOR IS INSTALLED AND OPERATING.
- DISCONNECT AND REMOVE (E) GENERATOR WIRING WHEN NO LONGER NEEDED. REMOVÉ ABOVE GRADE CONDUIT AND ELECTRICAL EQUIPMENT NO LONGER NEEDED.

SHEET NOTES:

COORDINATE A POWER SHUTDOWN WITH PG&E AND OWNER REPESENTATIVE.


> USE (E) GENERATOR TO PROVIDE TEMPORARY POWER TO (E) PANEL "EM" AND DATA CENTER.

DISCONNECT THE (E) PG&E SERVICE CABLES AND ALL OTHER FEEDER CABLES FROM (E) MSB.

RC (E) IEM SWBD AND INSTALL A NEW SWBD IN THE. SAME LOCATION. SEE SHEET E-5 AND E-9 FOR WORK

RECONNECT ALL THE (E) CABLES TO (N) MSB.

- (2) INSTALL CHRISTY N30 PULL BOX WITH FIBRELYTE COVER, MARKED "COMM", SEE NOTE (13).
- 3 INSTALL (N) OWNER-FURNISHED 600 KW GENERATOR ON CONCRETÈ PAD.
- (3A) INSTALL (N) 600A MTS ON CONCRETE PAD. SEE ANCHÓRING DETAIL 3 ON SHEET E-8.
- INSTALL CONDUIT RUNS IN (E) $24\text{"W} \times 36\text{"DEEP}$ TRENCH. 3-4"C WITH CONDUCTORS PER NOTE 4 ON SHEET E-5. 1/2"C, 2#10 (GEN START)
- (4A) 1 1/2"C, 3#4 (GEN PANEL)
- (4B) 2"C, 1 BELDEN 9841 (REMOTE ANNUN) 1 - CAT5 (BLDG EMS)
- 4C 1"C, 1 BELDEN 9841 (REMOTE ANNUN)
- 4D 1"C, 1 CAT5 (BLDG EMS)
- (4E) 2"C, WITH CABLES PER NOTES (4B) AND (14).
- 5 COORDINATE WITH PG&E TO RE-CONNECT THE ELECTRIC SERVICE.
- 6 INSTALL CONDUIT RUNS IN CEILING SPACE.
- 7) INSTALL 2 SETS FEEDERS PER NOTE (5) ON SHEET E-6.
- (7A) INSTALL 1 SETS OF FEEDERS PER NOTE (5) ON SHEET E-5.
- (8) NOT USED.
- 9 SEE NOTE 9 ON SHEET E-3.
- (10) RC UNUSED CB'S AND INSTALL NEW 70A/2P FOR GEN ACCESSORIES PANEL.
- (11) PROVIDE 16"x16" ALUMINUM HAZARD SIGN. SEE ARCH

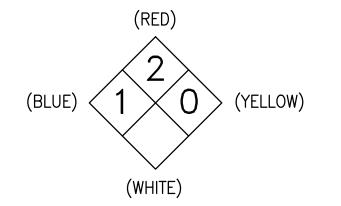


- (E) GEN ANNUN AND CONNECT (N) EMS CABLE TO EMS PANEL "TCP-5"
- UTILITY VAULT PULL BOX WITH SLIP RESISTANT METAL COVER. INSIDE DIMENSIONS: ±24"x36"x30"D.
- PROVIDE PULL BOX PER NOTE 15 EXCEPT INSIDE COVER. INSIDE DIMENSIONS: ±30"x48"x30"D.
- (16) SHEET METAL PULL BOXES IN CEILING SPACE FOR GEN AND MTS CABLES, INSIDE DIMENSIONS ±48"x48"x16"D.



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Santa Clara, CA 95054

PROJECT NO. 175-21-07

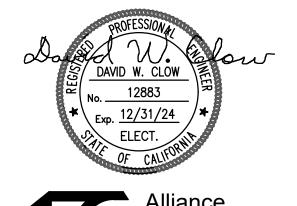S1 - SOUTH S2 - NORTH GENERATOR GENERATOR (E) E BLDG (E) N BLDG (E) S BLDG

Project Title

Key Plan

B 02_25_26 - RIDDER PARK NORTH & SOUTH BUILDING BACK UP GENERATOR BID SET

1290 RIDDER PARK DR., SAN JOSE CA 95131

SANTA CLARA COUNTY OFFICE OF EDUCATION


No.	Description	Date
1	BID SET	09.05.25

ENLARGED PLAN -NORTH BLDG #3 SERVICE

Consultant Seal


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Project Number

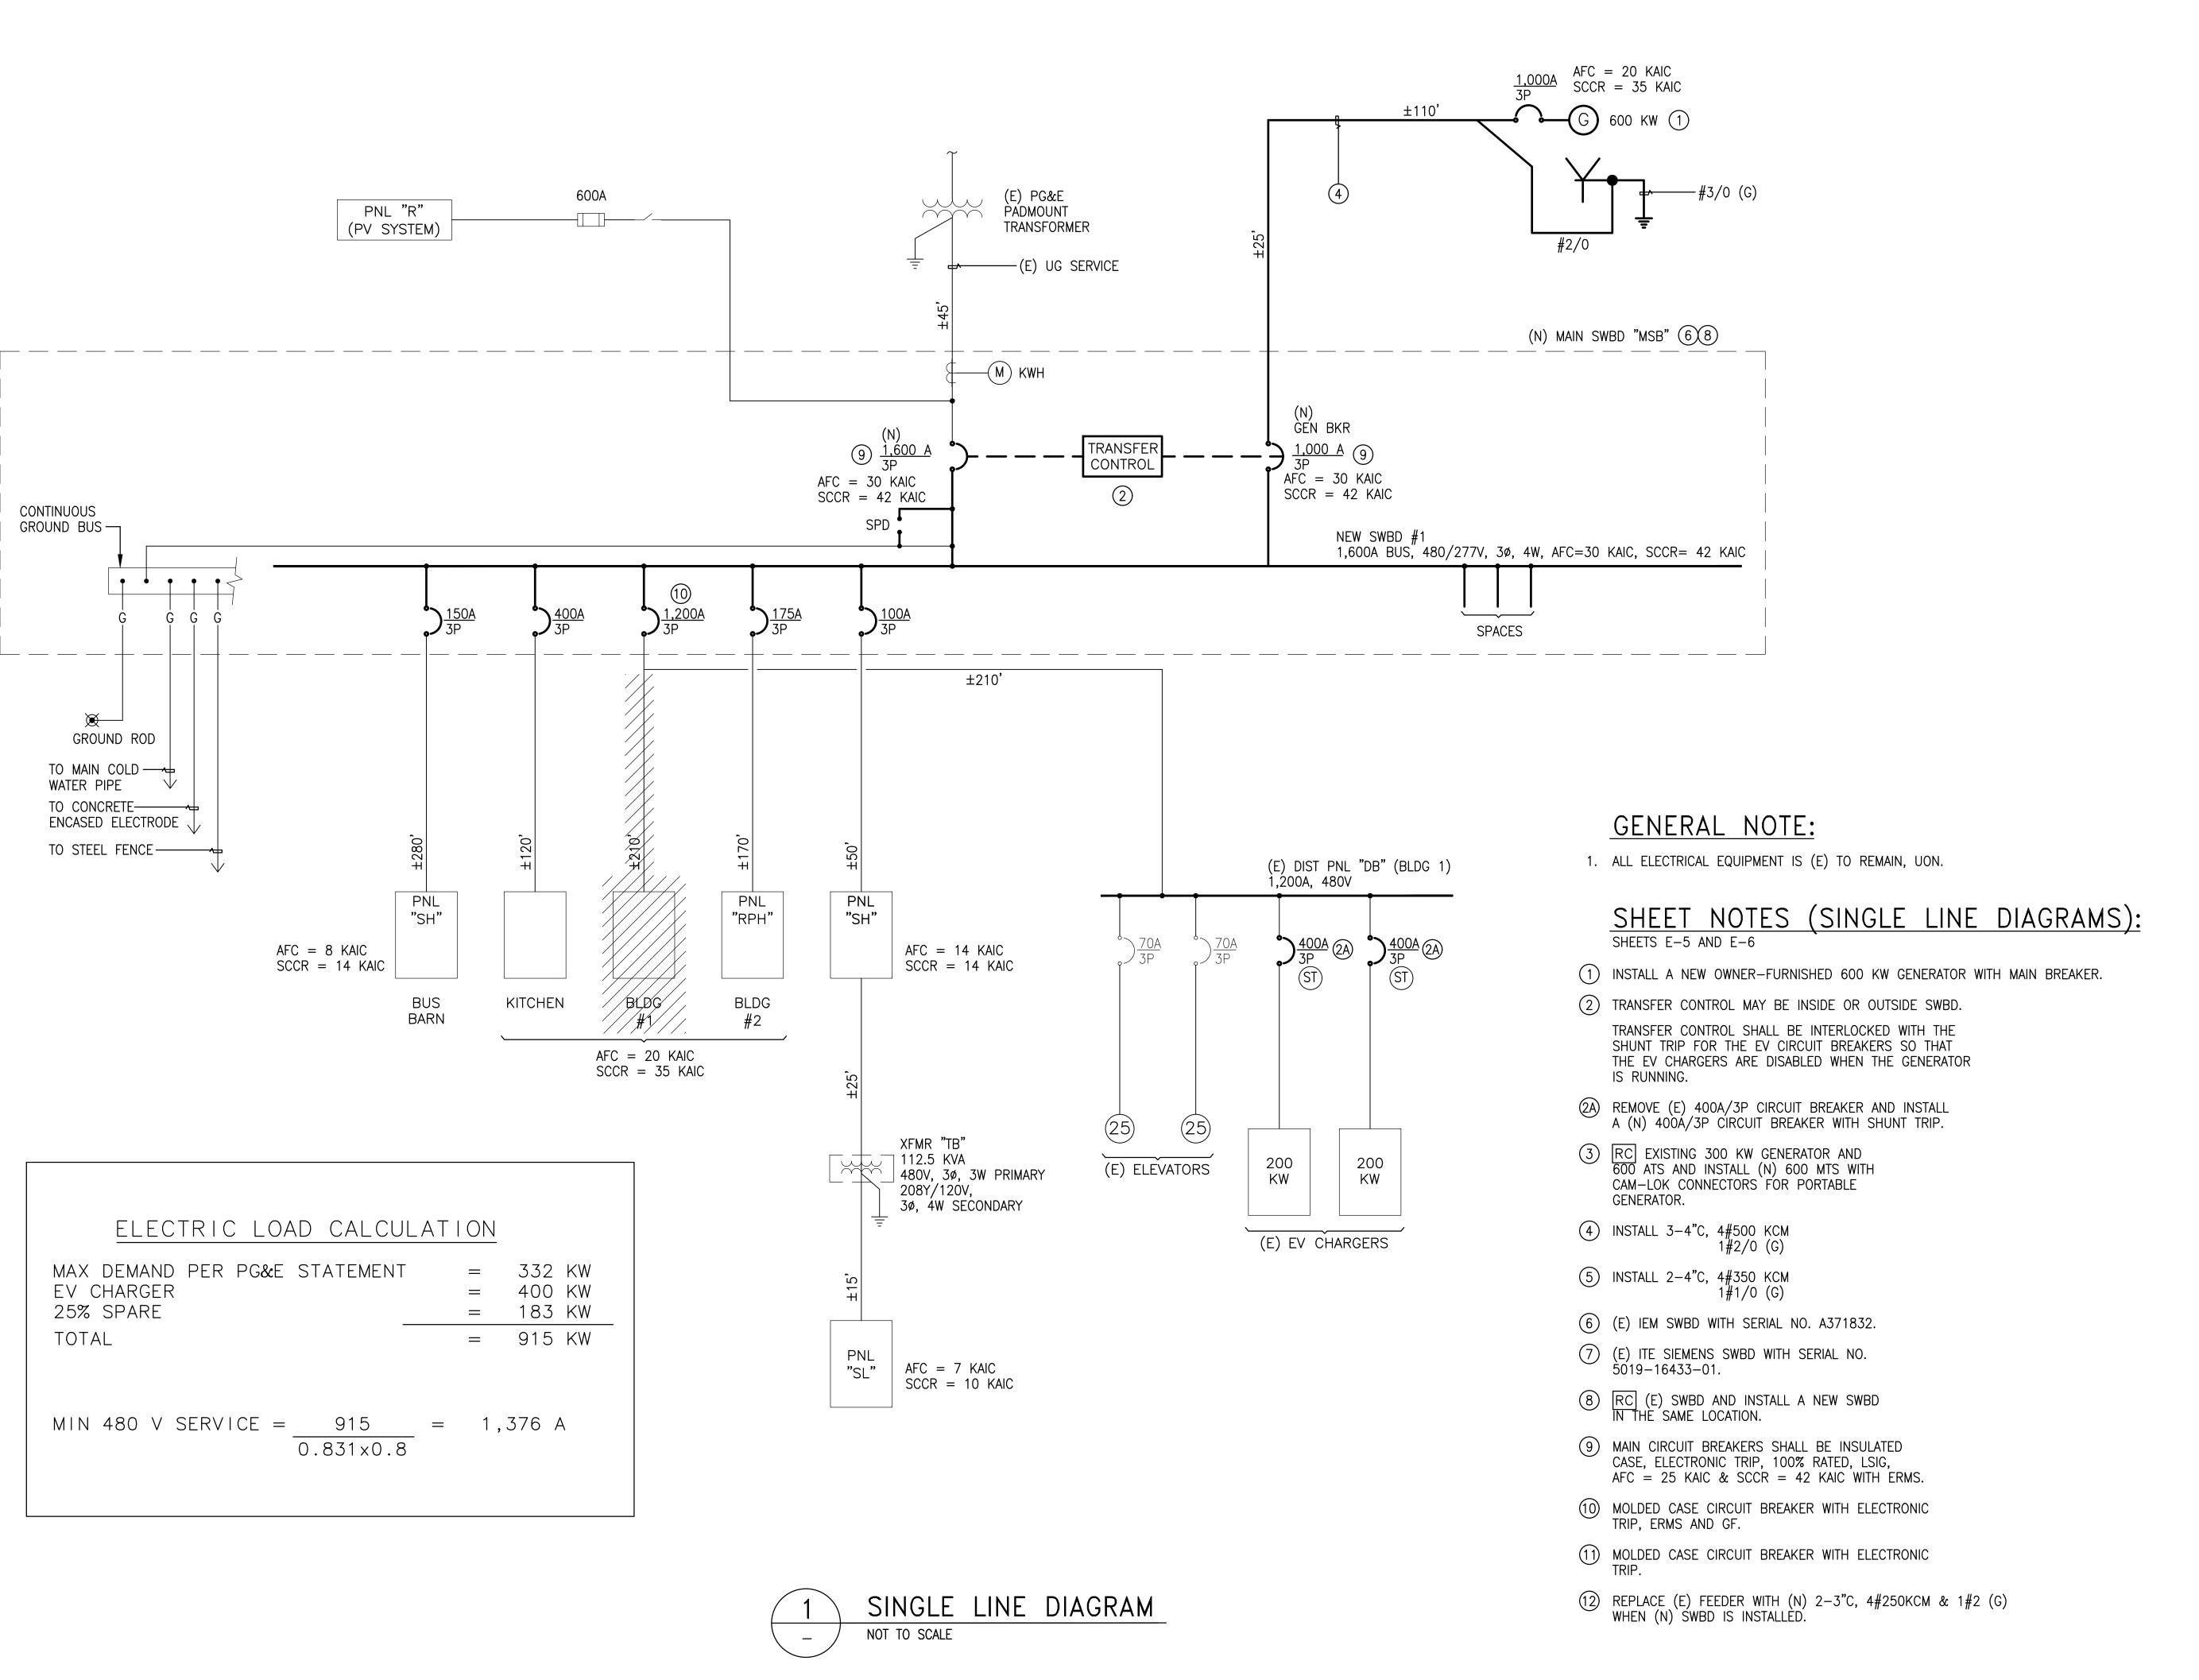

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Santa Clara, CA 95054 PROJECT NO. 175-21-07

Key Plan S1 - SOUTH S2 - NORTH **GENERATOR** GENERATOR (E) E BLDG (E) N BLDG (E) S BLDG

Project Title

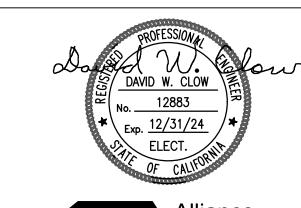B 02_25_26 - RIDDER PARK NORTH & SOUTH BUILDING BACK UP GENERATOR BID SET

1290 RIDDER PARK DR., SAN JOSE CA 95131

SANTA CLARA COUNTY OFFICE OF EDUCATION

T	
Description	Date
BID SET	09.05.25
	Description BID SET


Drawing Title


SINGLE LINE DIAGRAM BLDG #1

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Drawing No. 09. 05. 2025


Project Number



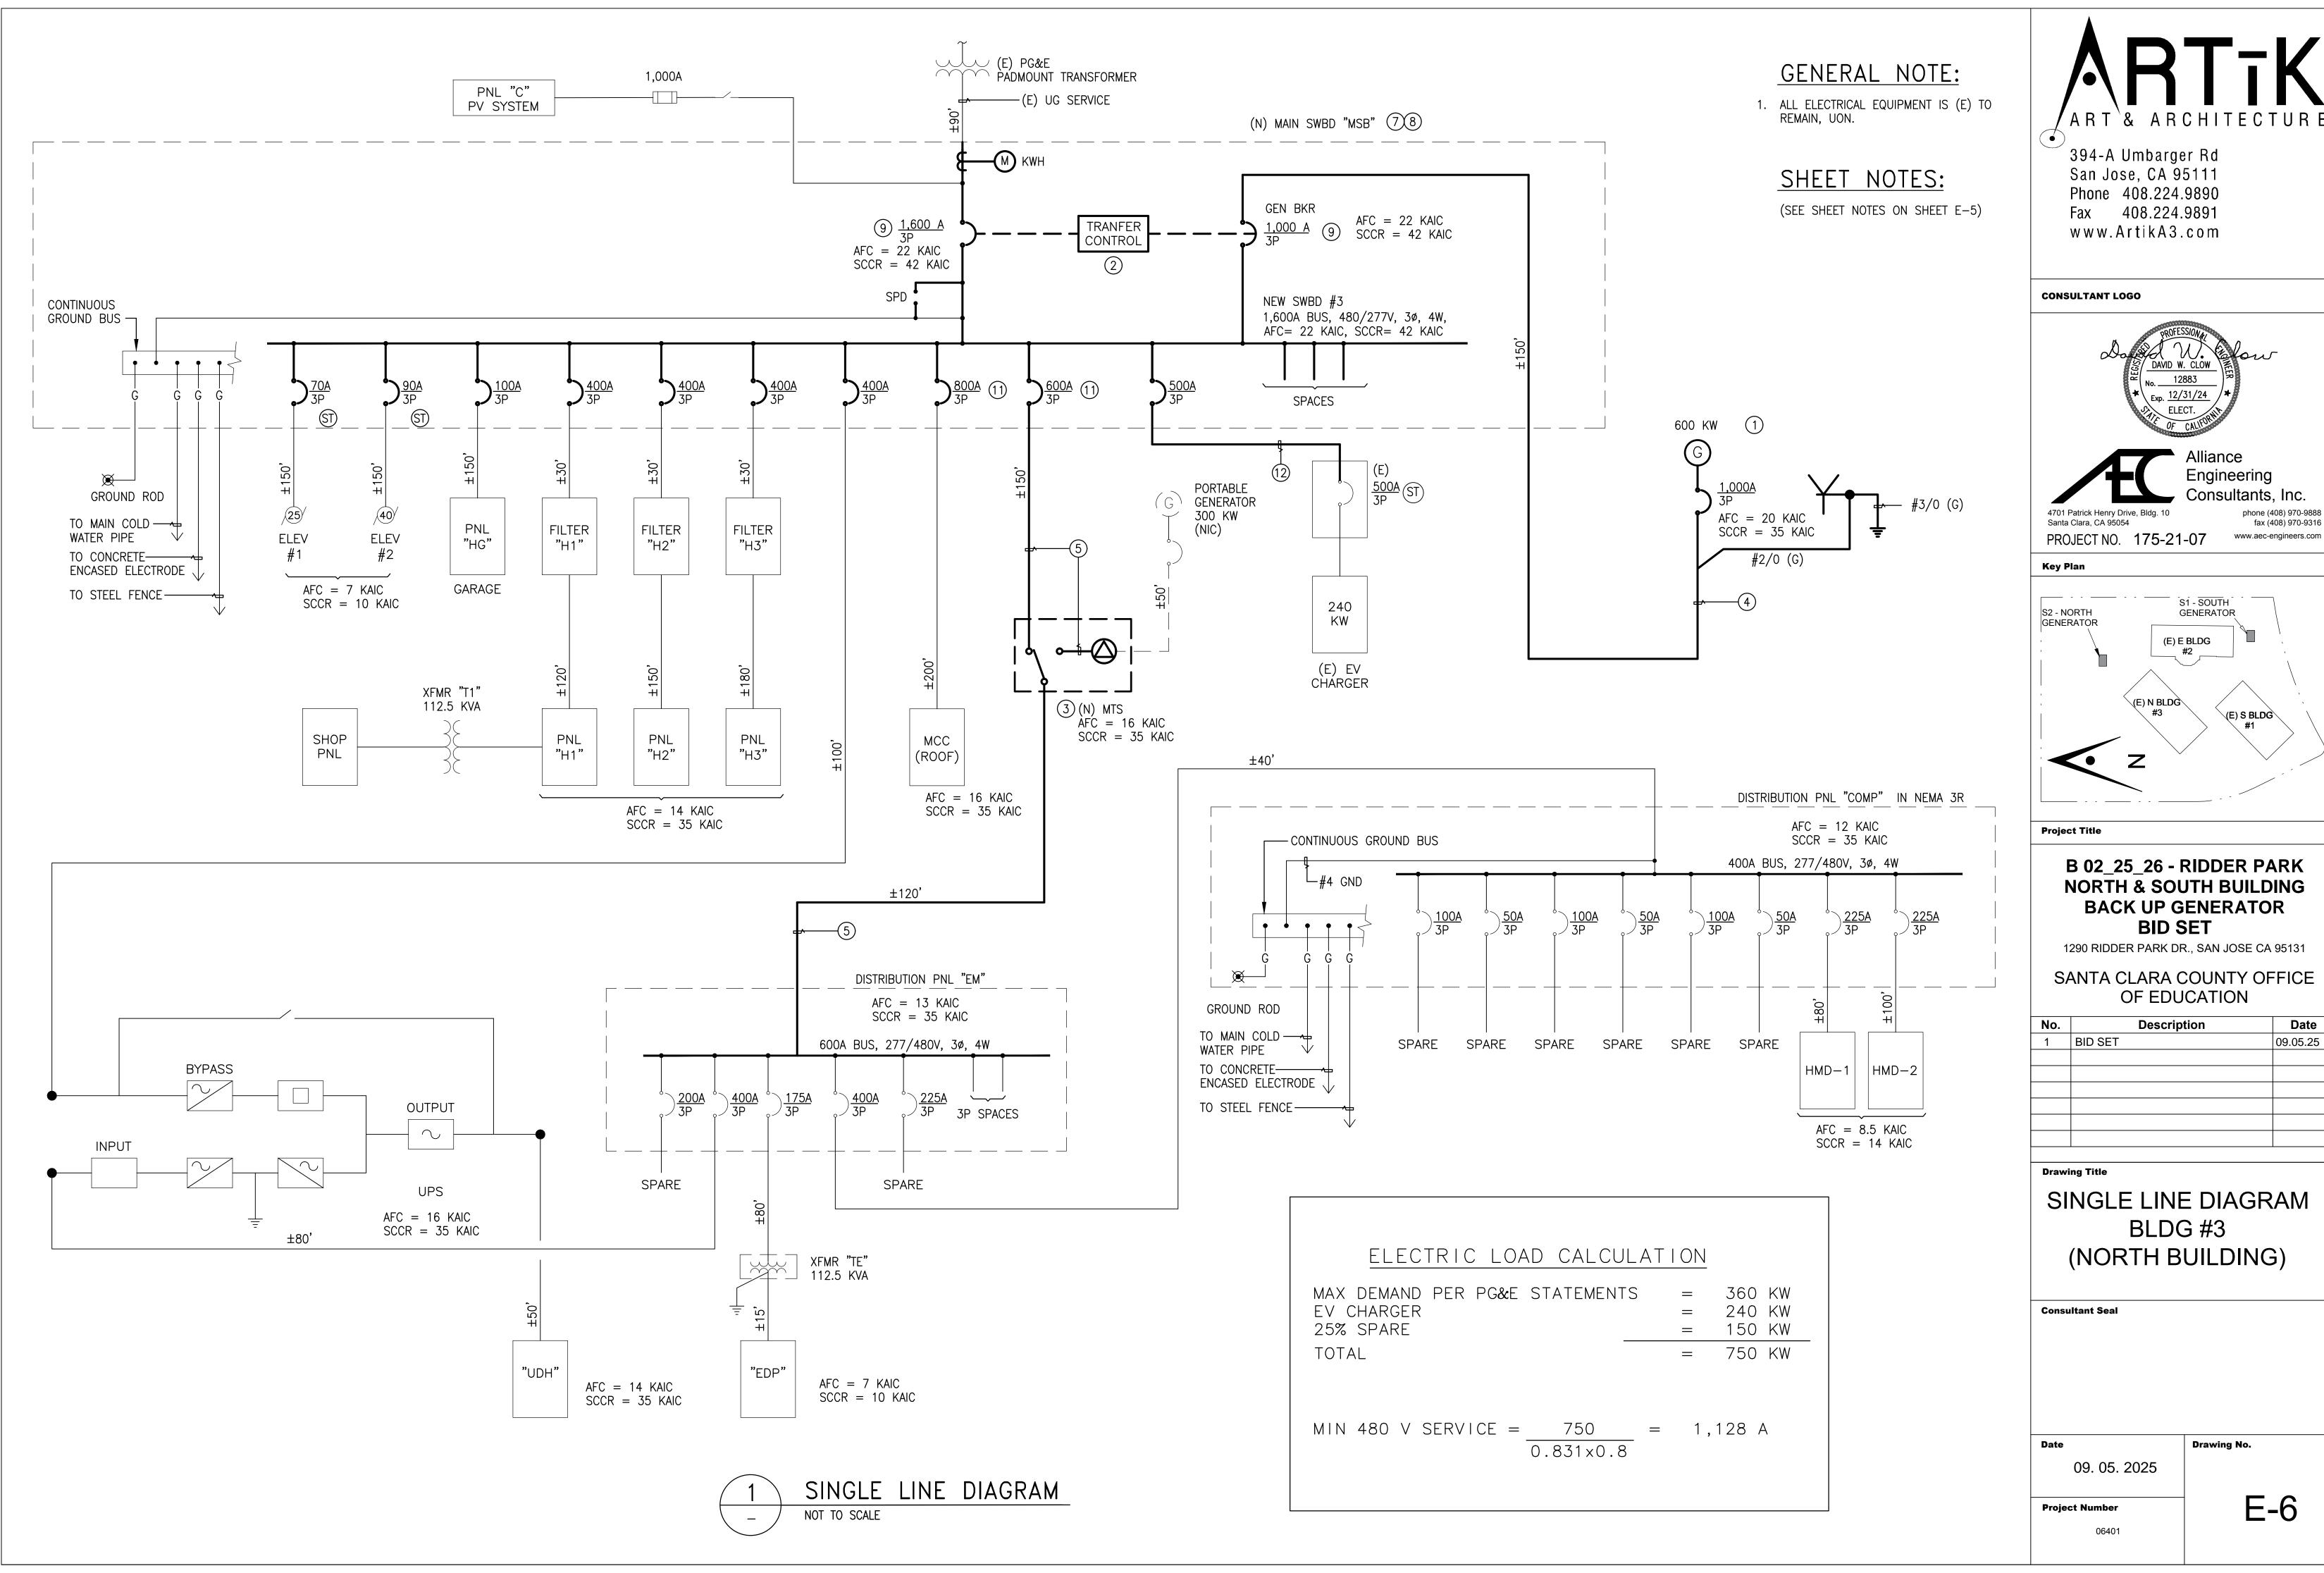


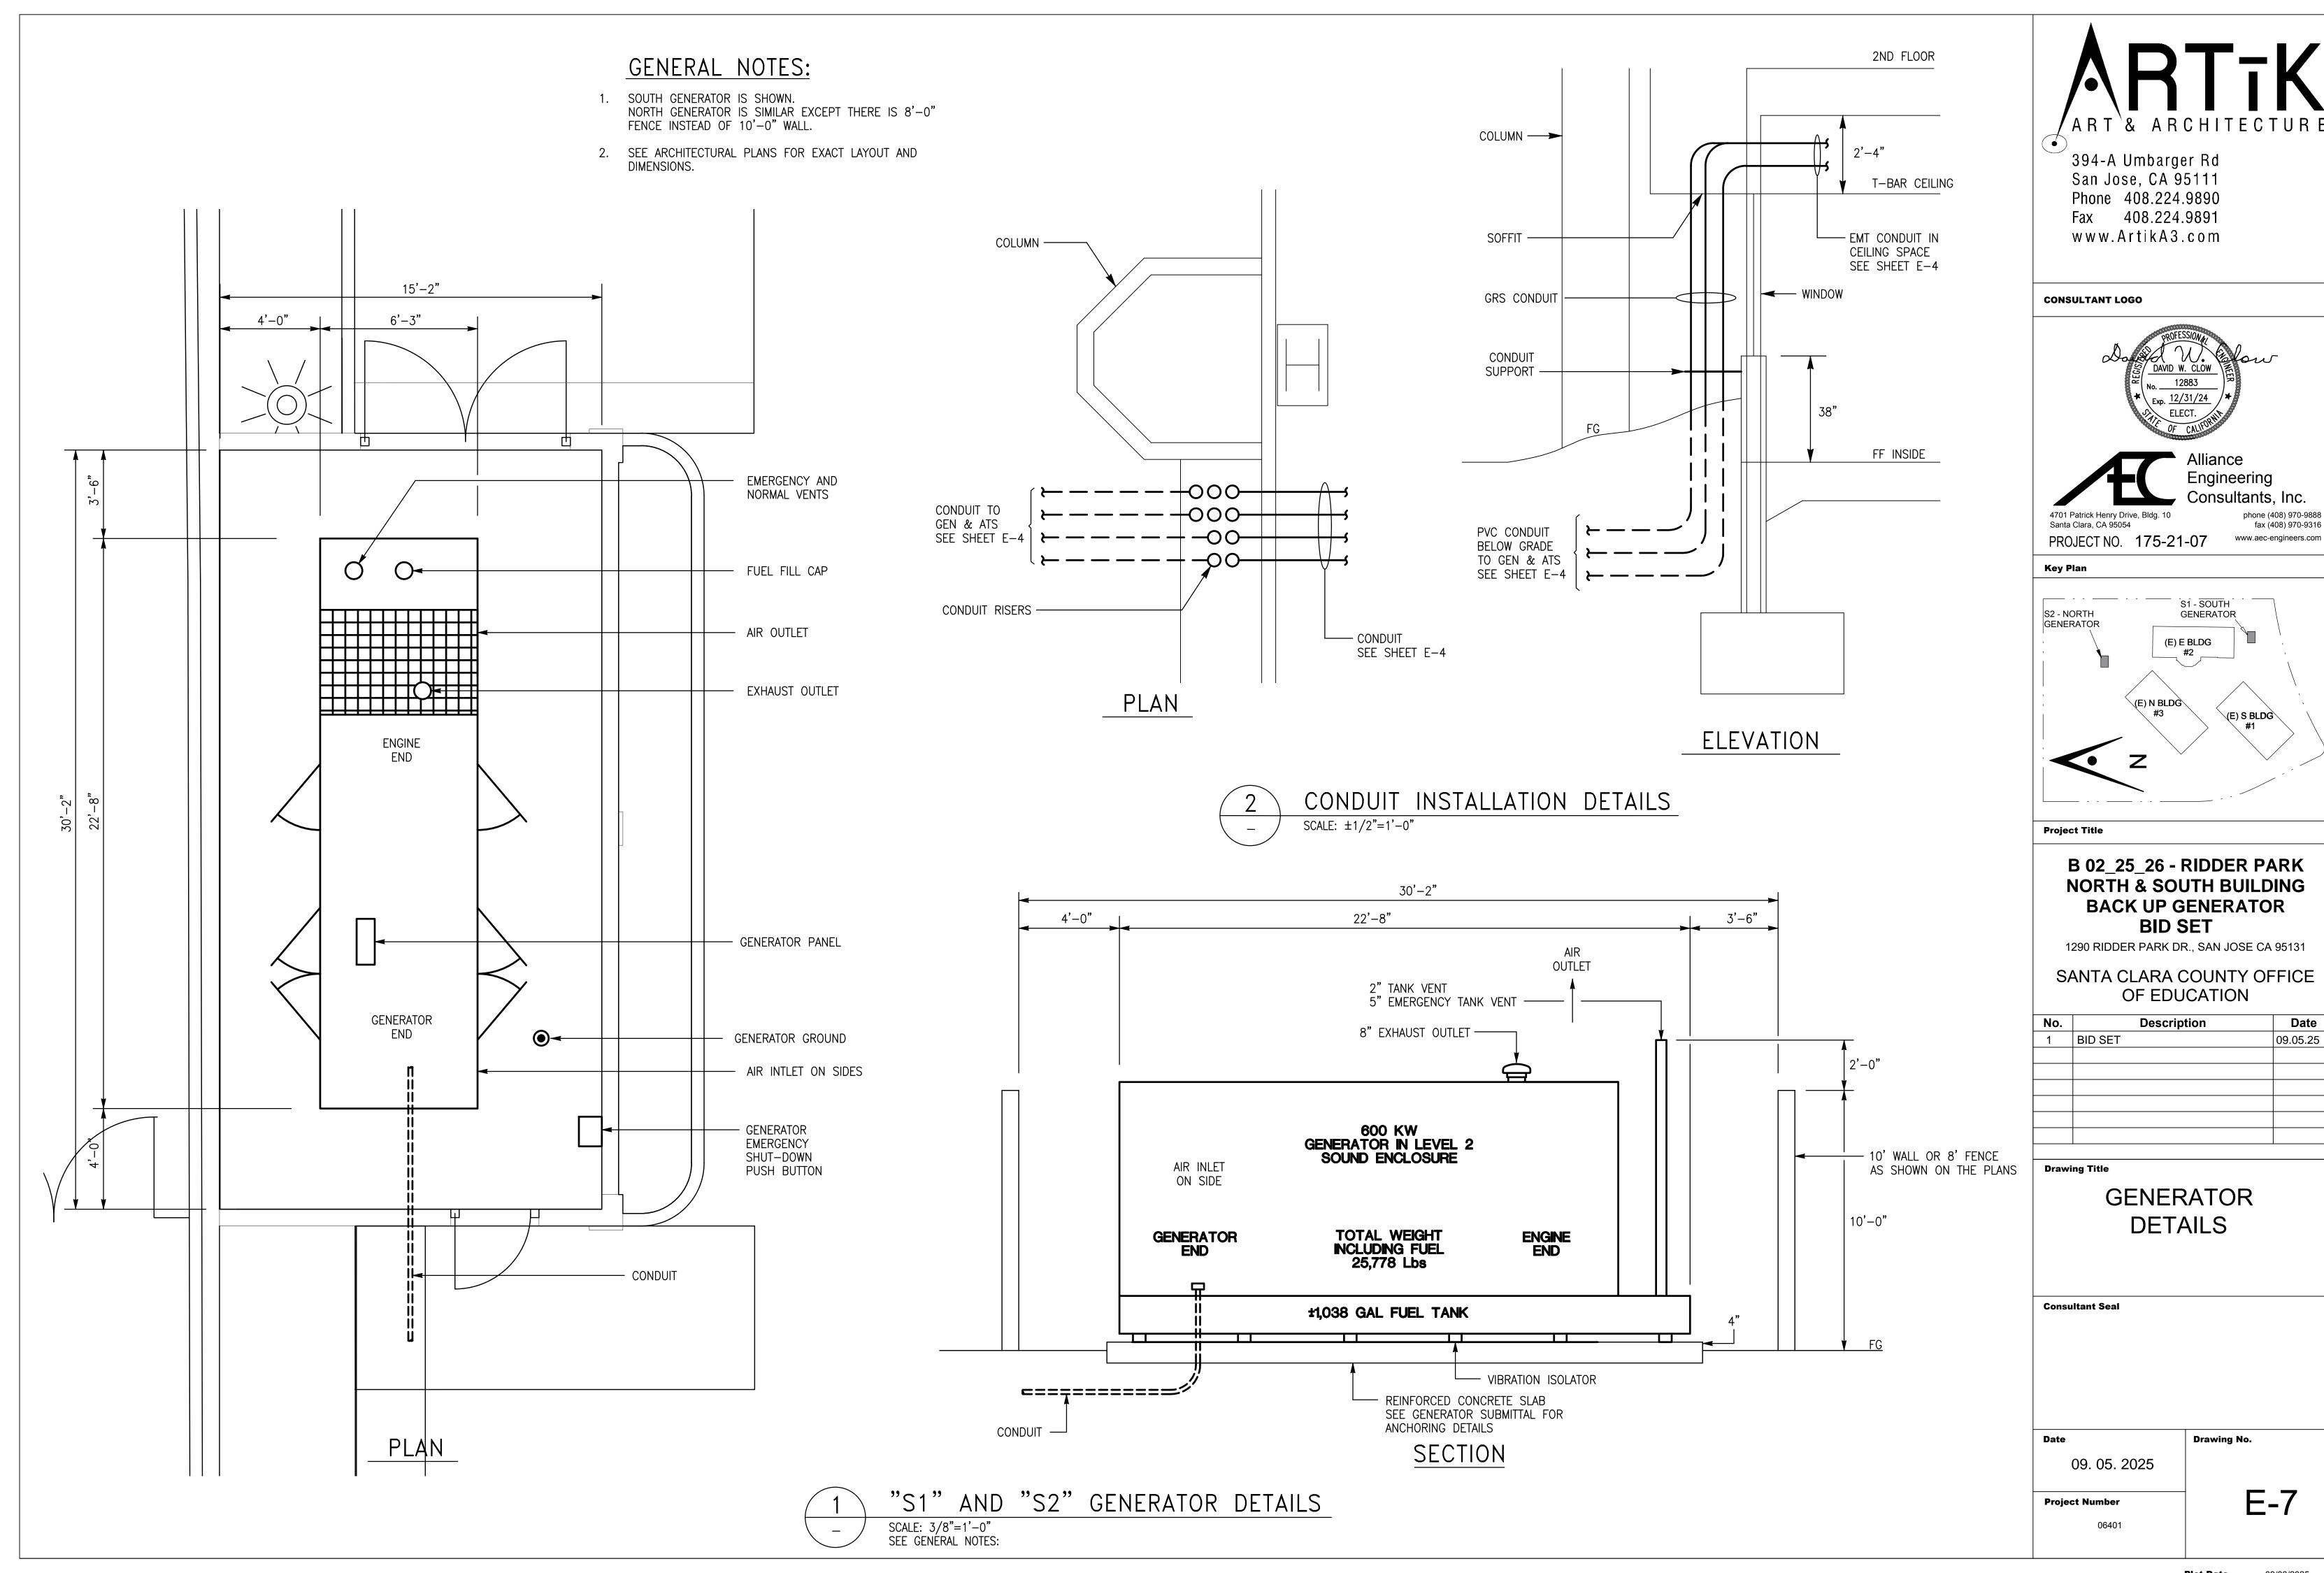SHEET NOTE:


- 1) RC EXISTING MAIN SWITCHBOARD AND INSTALL NEW MAIN SWITCHBOARD IN THE SAME LOCATION. SEE PLANS FOR DETAILS.
- (2) CIRCUIT BREAKERS WITH ELECTRICAL OPERATORS. THE PLC AND PROGRAMMED TRANSFER CONTROLS MAY BE LOCATED IN A SEPARATE CABINET.

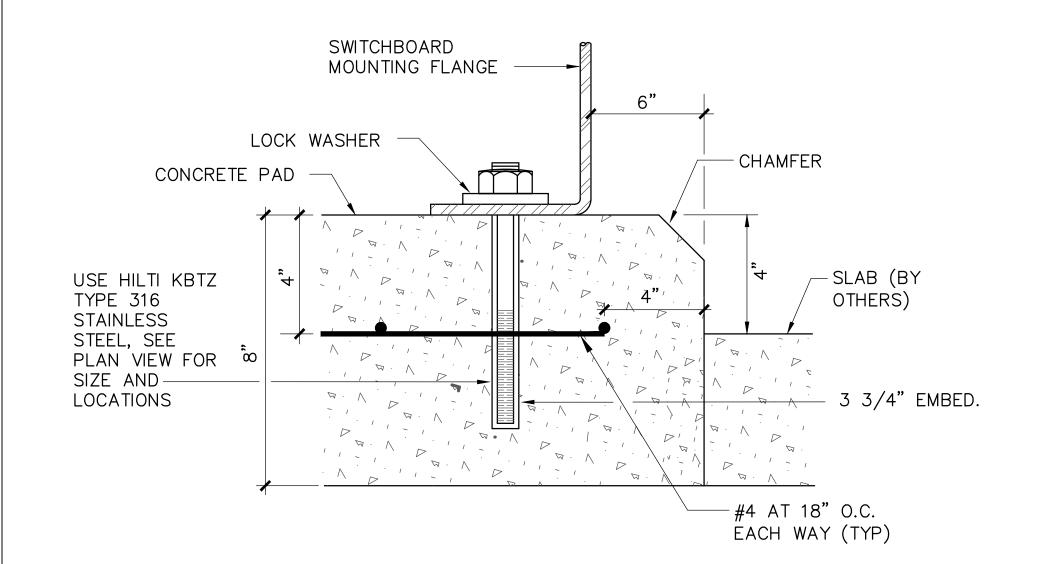

SWITCHBOARD ANCHORING DETAIL NOT TO SCALE

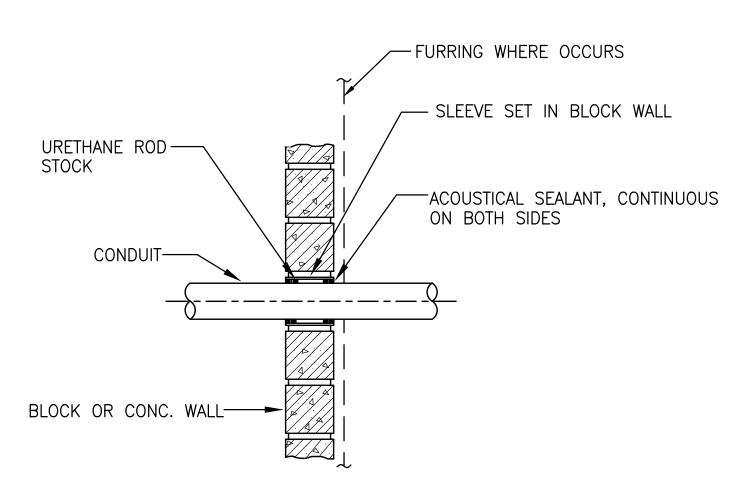

BLOCK OR CONCRETE WALL

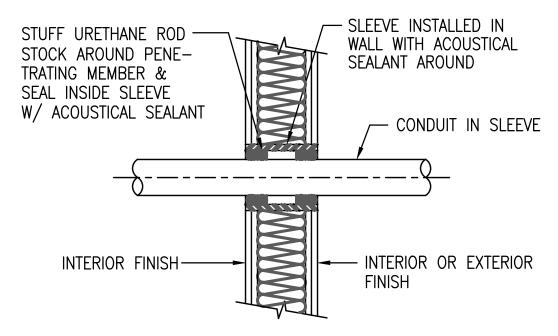


NOTE: PATCH AND FINISH TO MATCH (E)

THESE RECOMMENDATIONS ARE BASED ON PRODUCT PERFORMANCE PER ASTME-814(UL1479) FIRE TEST AND UL THROUGH PENETRATION FIRESTOP SYSTEM #WL1001.


STUDWALL

TYPICAL CONDUIT WALL PENETRATION DETAILS NOT TO SCALE

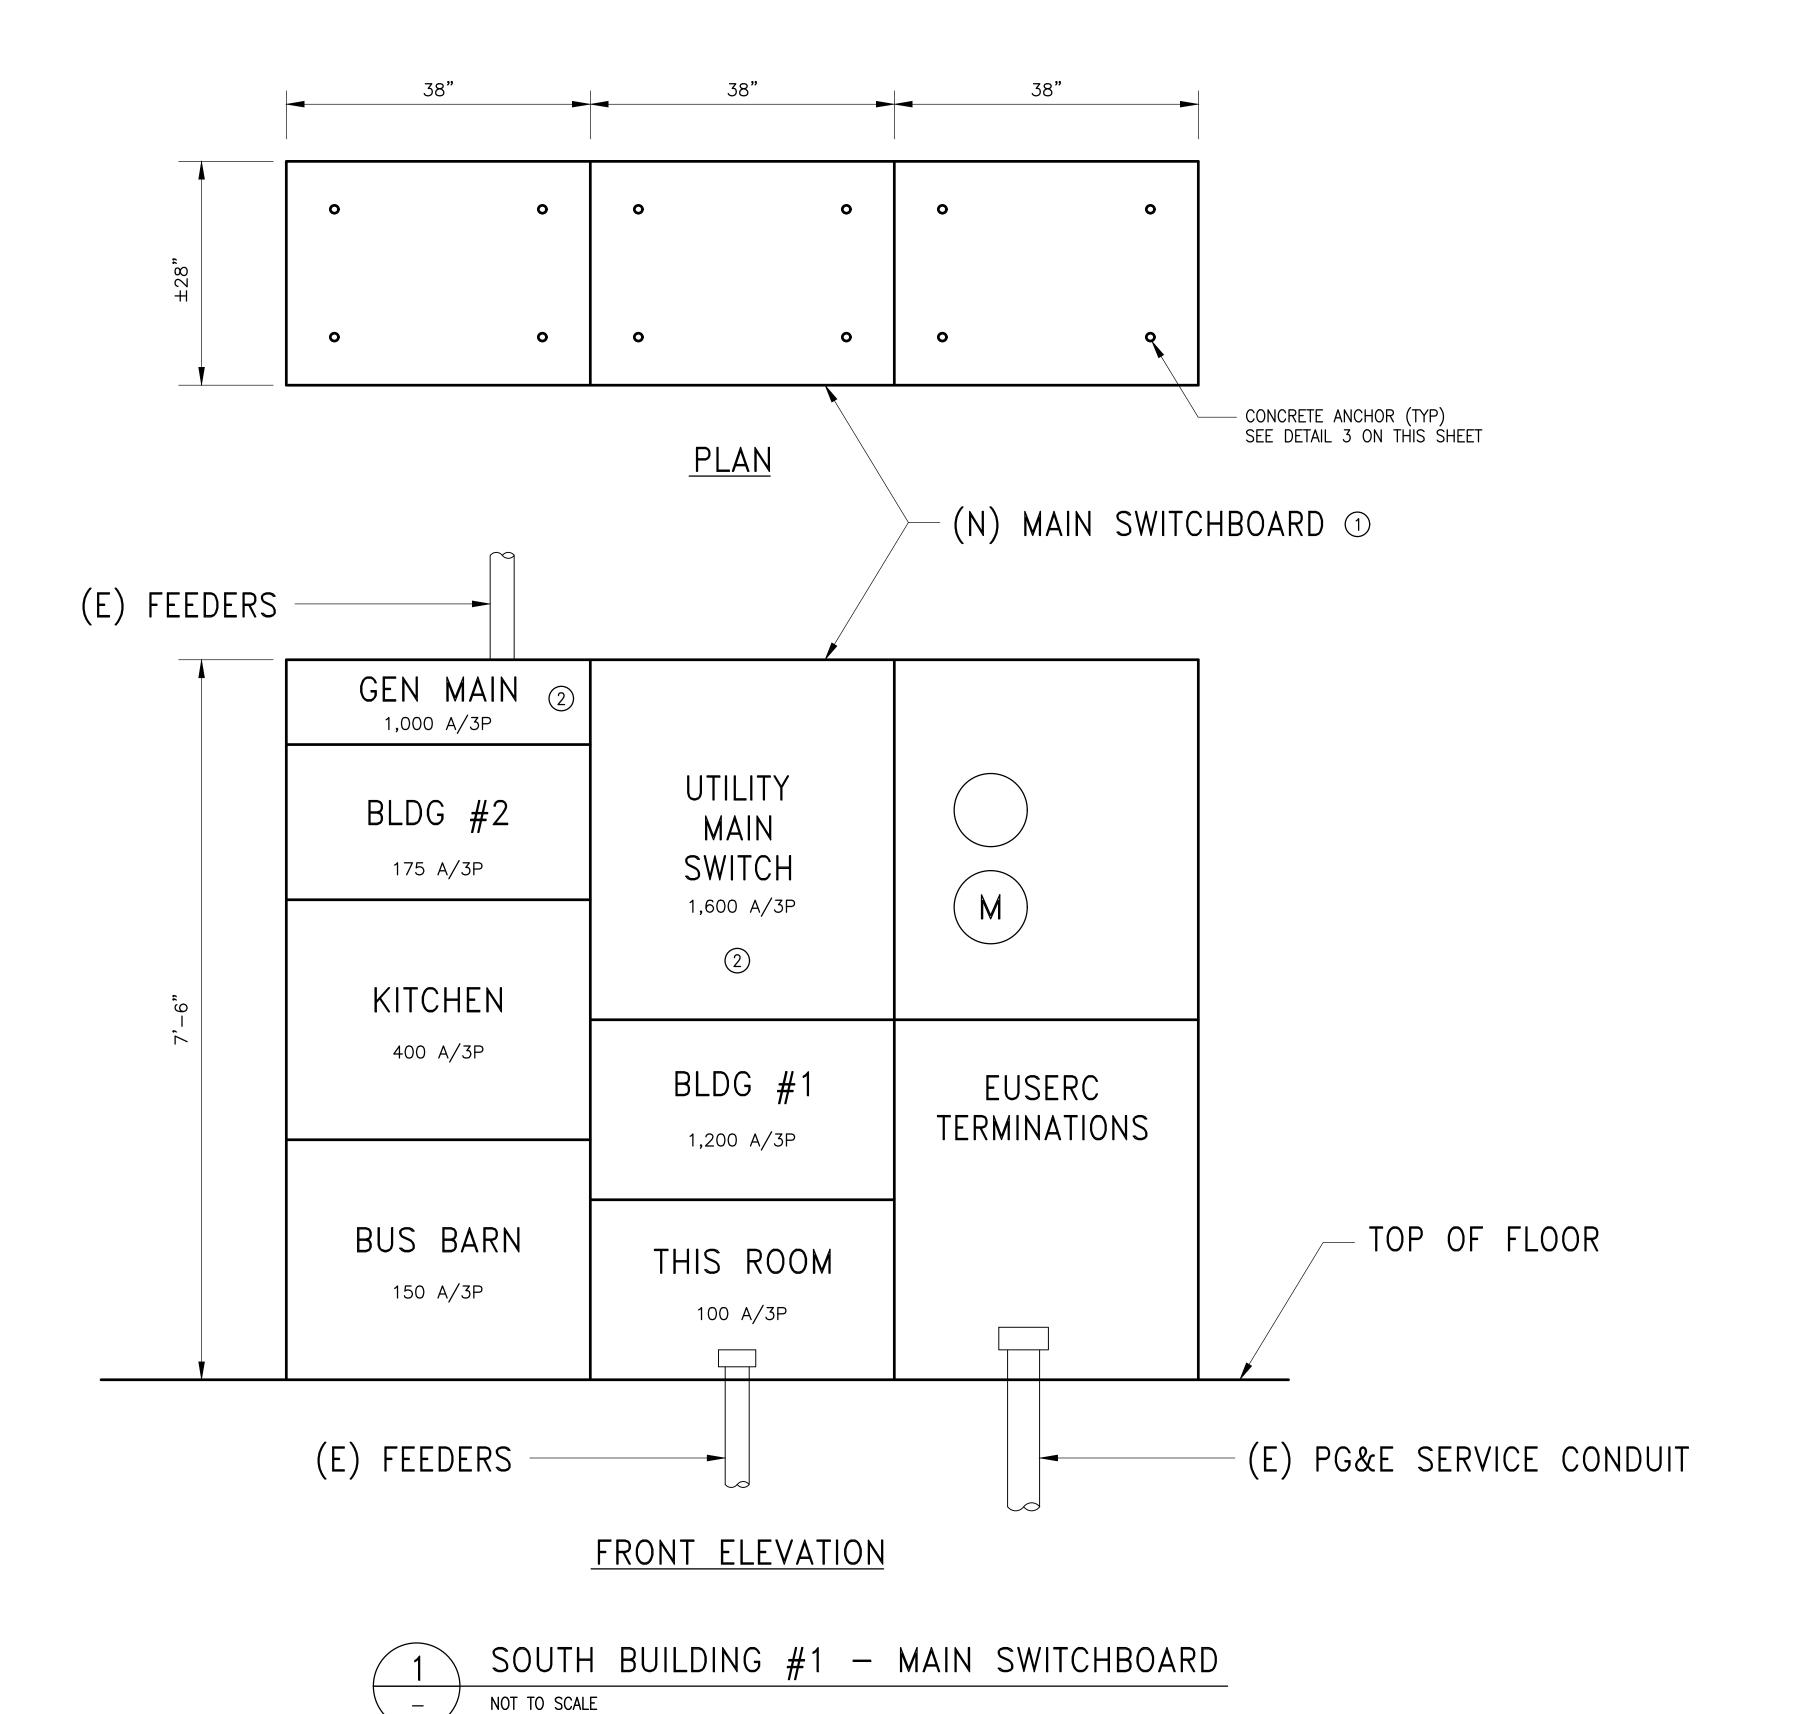

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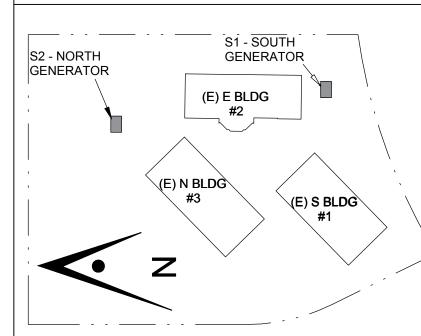


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PROJECT NO. 175-21-07

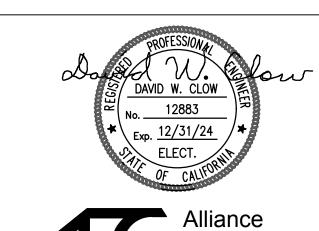Key Plan



Project Title

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1290 RIDDER PARK DR., SAN JOSE CA 95131

SANTA CLARA COUNTY OFFICE OF EDUCATION

	T	T
No.	Description	Date
1	BID SET	09.05.25

Drawing Title

SWITCHBOARD **DETAILS BUILDING #1**

Consultant Seal

09. 05. 2025


Project Number

E-8

Drawing No.

SHEET NOTES:

- 1 RC EXISTING MAIN SWITCHBOARD AND INSTALL NEW MAIN SWITCHBOARD IN THE SAME LOCATION. SEE PLANS FOR DETAILS.
- 2 EXISTING ATS SHALL REMAIN IN OPERATION UNTIL THE NEW PROGRAMMED TRANSFER CONTROL IS COMMISSIONED AND IN OPERATION AND THEN REMOVE.
- 3 CIRCUIT BREAKERS WITH ELECTRICAL OPERATORS.

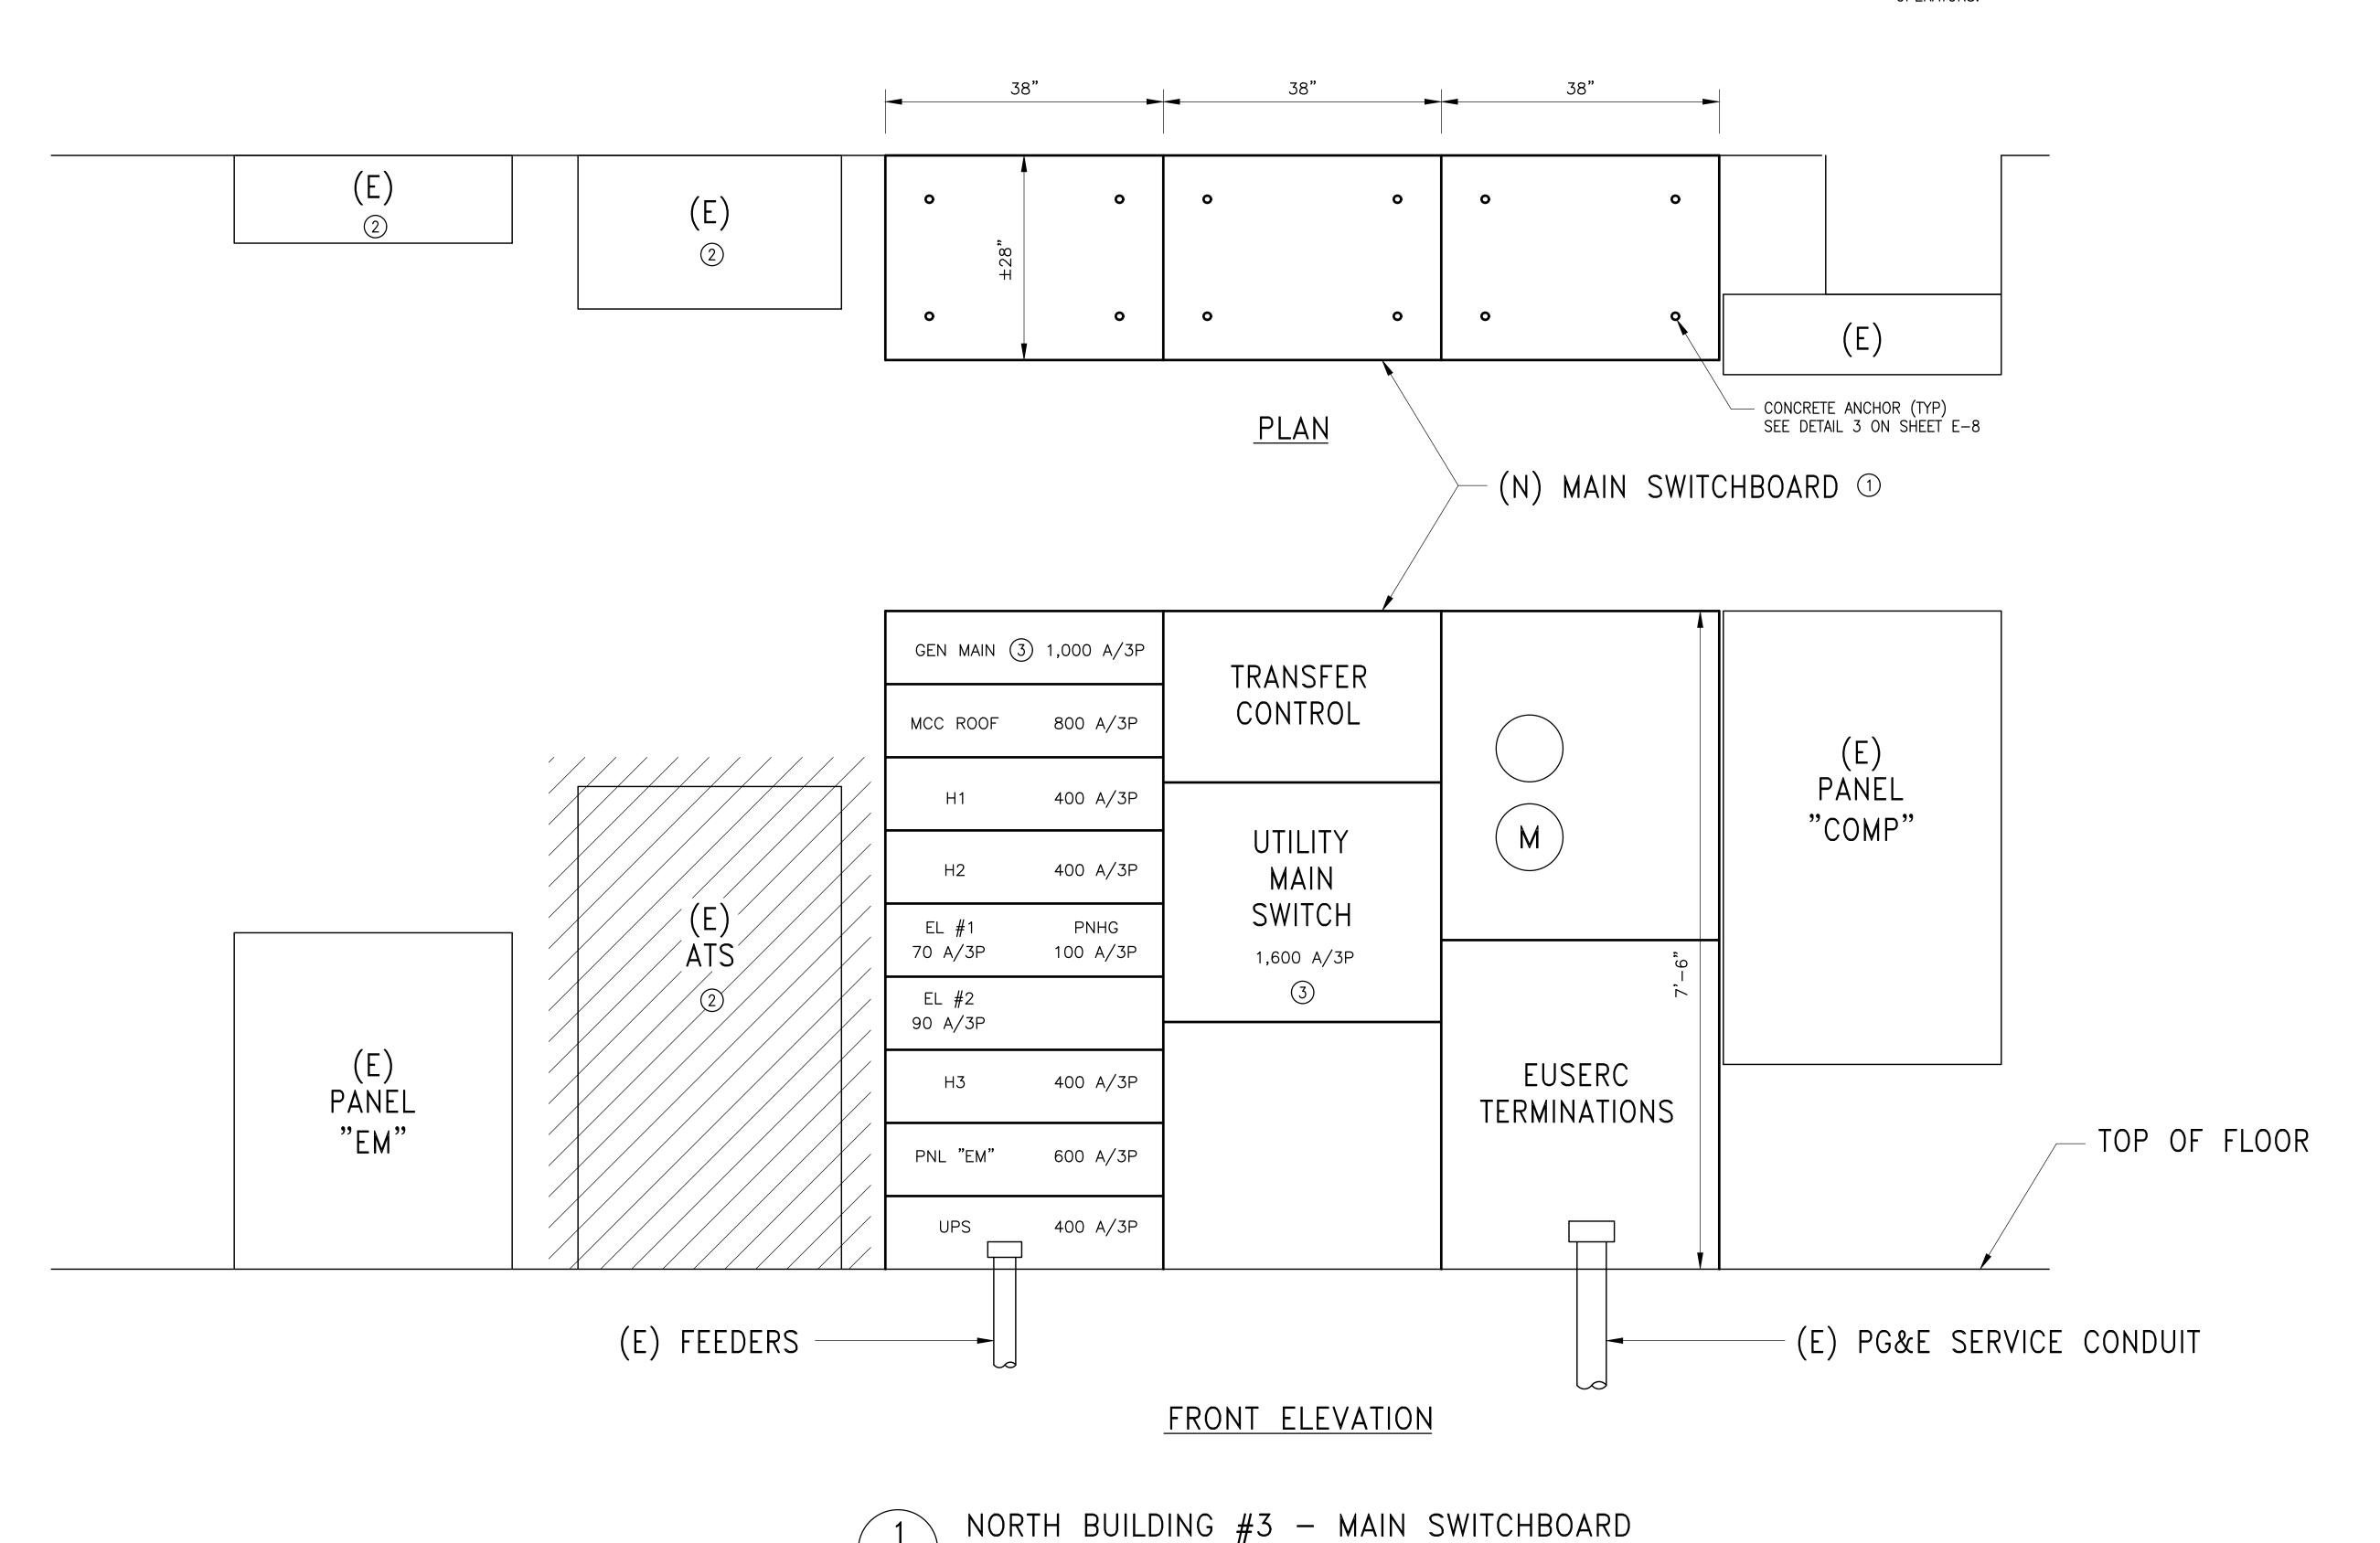


NOT TO SCALE



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Santa Clara, CA 95054

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Consultants,
phone (44)
fax (44)

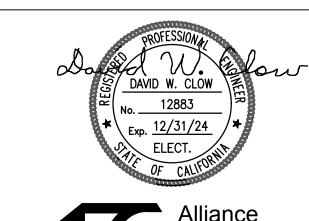Santa Clara, CA 95054
PROJECT NO. 175-21-07

· ¬-

S1 - SOUTH
GENERATOR

(E) E BLDG

#2

(E) S BLDG

#1

Project Title

B 02_25_26 - RIDDER PARK NORTH & SOUTH BUILDING BACK UP GENERATOR BID SET

1290 RIDDER PARK DR., SAN JOSE CA 95131

SANTA CLARA COUNTY OFFICE OF EDUCATION

No.	Description	Date
1	BID SET	09.05.25
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Drawing Title

SWITCHBOARD DETAILS BUILDING #3

Consultant Seal

09. 05. 2025

Project Number

E-9

Drawing No.



May 15, 2023

AEC Engineers Attn: Dave & Sudha

Re: Fault Current Request for 1290 Ridder Park Dr, San Jose - North Building

To Whom It May Concern,

This letter is regarding your recent request about the available short circuit duty at the above location. The available short circuit duty from the PG&E system will not exceed 22,000 Amperes 3 phase RMS symmetrical.

These short circuit duty calculations include the following conditions:

- 1. The secondary service voltage of 277/480 Volt, 3-Phase, 4 Wire from PG&E.
- 2. The building's ultimate electric demand reaches but does not exceed present main switch size of 1200 amps and the service length will be no greater than approximately 90' feet.

Any increase in the power main switch over which we have no control would change this calculated value, and the 22,000 Amperes short circuit duty would no longer be valid.

If you have any questions, please call me at (408) 598-6987

Sincerely,

Daniel Wong

Daniel Wong Senior New Business Representative

> 308 Stockton Avenue, San Jose, CA 95126 | 408-299-9500 Main | 408-299-9509 Fax Public



May 15, 2023

AEC Engineers Attn: Dave & Sudha

Re: Fault Current Request for 1290 Ridder Park Dr, San Jose - South Building

To Whom It May Concern,

This letter is regarding your recent request about the available short circuit duty at the above location. The available short circuit duty from the PG&E system will not exceed 30,000 Amperes 3 phase RMS symmetrical.

These short circuit duty calculations include the following conditions:

- 1. The secondary service voltage of 277/480 Volt, 3-Phase, 4 Wire from PG&E.
- 2. The building's ultimate electric demand reaches but does not exceed present main switch size of 1200 amps and the service length will be no greater than approximately 45' feet.

Any increase in the power main switch over which we have no control would change this calculated value, and the 30,000 Amperes short circuit duty would no longer be valid.

If you have any questions, please call me at (408) 598-6987


Sincerely,

Daniel Wong

Daniel Wong Senior New Business Representative

> 308 Stockton Avenue, San Jose, CA 95126 | 408-299-9500 Main | 408-299-9509 Fax Public



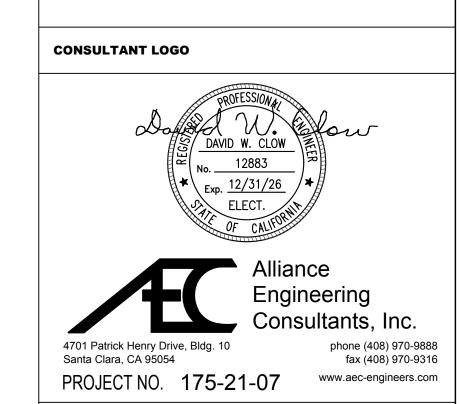

S2 - NORTH
GENERATOR

(E) E BLDG

#2

(E) S BLDG

#1

Project Title

B 02_25_26 - RIDDER PARK NORTH & SOUTH BUILDING BACK UP GENERATOR BID SET

1290 RIDDER PARK DR., SAN JOSE CA 95131

SANTA CLARA COUNTY OFFICE OF EDUCATION

No.	— 1.71	
NO.	Description	Date
1	BID SET	09.05.25

Drawing Title

PG&E SHORT CIRCUIT LETTERS

Consultant Seal

Drawing No. 09. 05. 2025

Project Number